GENERAL CONSTRUCTION NOTES

- 1. THE CONTRACTOR SHALL EXAMINE ALL AREAS IN WHICH HIS/HER WORK IS TO BE INSTALLED, AND SHALL REPORT ANY UNSUITABLE CONDITIONS. THE CONTRACTOR WILL BE HELD RESPONSIBLE FOR CONDITIONS OF THE FINISHED WORK AND NO CLAIM AS TO DEFECTS IN UNDERLYING WORK IS CONSIDERED AFTER WORK UNDER THIS CONTRACT IS STARTED.
- 2. THE CONTRACTOR, BEFORE STARTING ANY WORK, SHALL VERIFY ALL DIMENSIONS AND LEVELS GIVEN FOR WORK UNDER THIS CONTRACT, IN CONJUNCTION WITH ARCHITECT'S OF ENGINEER'S DRAWINGS AND DETAILS.
- 3. DEMOLITION SHALL BE CARRIED OUT ACCORDING TO THE RULES OF THE DEPARTMENT OF BUILDINGS AND NOT WITHOUT TIMELY NOTIFICATION TO THE BUILDING DEPARTMENT.
- 4. BUILDING TO CONFORM WITH APPLICABLE PROVISIONS OF THE MULTIPLE DWELLING HOUSING MAINTENANCE CODE & BUILDING DEPARTMENT'S RULES AND REGULATIONS
- 5. ALL WORK SHALL BE IN ACCORDANCE WITH ALL APPLICABLE RULES OF THE BUILDING CODE AND ANY OTHER AUTHORITY HAVING JURISDICTION. NO WORK SHALL BEGIN AT THE SITE UNTIL BUILDING DEPARTMENT APPROVAL AND REQUIRED PERMITS HAVE BEEN OBTAINED.
- 6. CONTROLLED INSPECTIONS:

ZONING MAP:12C

BLOCK NO: 2379

LOT NO: 12

- -FIRE STOPPING
- -MECH./ VENTILATION
- -STRUCTURAL/STABILITY
- -STEEL: BOLTED CONNECTIONS AND WELDING -CONCRETE/FOOTINGS
- -REINFORCING

TENANT SAFETY NOTES

- 1. CONSTRUCTION WILL BE CONFINED TO AREA INDICATED, AND WILL NOT CREATE DUST, DIRT OR OTHER SUCH INCONVENIENCES TO APARTMENT UNITS WITHIN THE BUILDING.
- 2. CONSTRUCTION OPERATION WILL NOT BLOCK HALLWAYS OR MEANS OF EGRESS FOR TENANTS OF THE BUILDING.
- 3. CONSTRUCTION OPERATION WILL NOT INVOLVE INTERUPTION OF HEATING, GAS, WATER OR ELECTRICAL SERVICES TO OTHER OCCUPANTS OF THE BUILDING.
- 4. CONSTRUCTION OPERATIONS WILL BE CONFINED TO NORMAL WORKING HOURS DETERMINED BY THE BUILDING'S REGULATIONS.
- 5. THE STRUCTURAL INTEGRITY OF THE BUILDING IS TO BE PROTECTED AT ALL TIMES.
- 6. BUILDING SECURITY TO BE MAINTAINED TO PREVENT UNAUTHORIZED PERSONS FROM ENTERING BUILDING.

156.7

94 N. 1st STREET

ADJ EXIST

2 STORY

BLDG

SEE SITEPLAN

INFO

A-001 FOR ADD'L

MX-8 IN MI-2/R6A/e2

R6-A W C2-4 OVERLAY

EXIST. STREET LAMP — TEXIST. CURB CUT

/STØRY/

ADDITION/

STEEL STUD/

/MAŚONŔY,

1/STØRY/

EXISTING BRICK

24.91

PLOT PLAN

SEE SURVEY AND

SITEPLAN FOR ADD'L INFO

ADJ

EXIST

STORY

BLDG

7. ALL EXISTING EXITS, FIRE PROTECTION DEVICES AND ALARMS SHALL BE CONTINUOUSLY MAINTAINED IN WORKING ORDER.

ZONING: MX-8, MI-2/R6A, e2 AND R6A W/ C2-4 OVERLAY

DESCRIPTION: ADDITION TO EXISTING BUILDING,

CONVERSION TO SINGLE FAMILY RESIDENTIAL.

ADDRESS: 94 N. 1 ST BROOKLYN. NY


COMMUNITY DISTRICT: BROOKLYN COMMUNITY DISTRICT 1

HOUSING MAINTENANCE NOTES

- 1. PAINTING OF PUBLIC PARTS & WITHIN DWELLING TO COMPLY WITH SECTION D26-12.01 H.M.C. & SECTION 80 M.D.L.
- 2. PAINTING OF WINDOW FRAMES & FIRE ESCAPES TO COMPLY WITH SECTION D26-12.03 H.M.C.
- 3. WALLS OF COURTS & SHAFTS TO BE OF LIGHT COLORED SURFACE AS PER SECTION D26-12.05 H.M.C. & SECTION 29 M.D.L.
- 4. PREMISES TO BE MAINTAINED & KEPT FREE OF RODENT & INSECT INFESTATION AS PER SECTION D26-13.03 & D26-13.05 H.M.C.
- 5. RECEPTACLES FOR THE COLLECTION OF WASTE MATTER TO BE PROVIDED AS PER SECTION D.26-14.03 & D26-14.05 H.M.C. & SECTION 81 M.D.L.
- 6. DRAINAGE OF ROOFS, COURTS, & YARDS TO COMPLY WITH SECTION D26-16.03 H.M.C. & SECTION 77 SUBD. 3 M.D.L.
- 7. YEARLY INSPECTION OF CENTRAL HEATING PLANT BY QUALIFIED PERSON TO BE MADE AS PER SECTION D26-17.05 H.M.C. CENTRAL HEAT & HOT WATER TO BE PROVIDED AS PER SECTION 79 SUBD. 1 M.D.L.
- 8. PROPER ELECTRIC LIGHTING EQUIPMENT WITHIN DWELLING TO BE PROVIDED & MAINTAINED AS PER SECTION D26-19.01, D26-19.03 & D26-19.05 H.M.C.
- 9. PROPER ELECTRIC LIGHTS TO BE PROVIDED NEAR ENTRANCE WAYS, YARDS, & COURTS AS PER SECTION D26-19.07 H.M.C. ON SEPARATE CIRCUITS OR CONNECTED TO HOUSE LINE SERVICING PUBLIC HALLS, & IN ACCORDANCE WITH REQUIREMENTS & APPROVAL OF THE DEPT. OF WATER SUPPLY, GAS & ELECTRICITY AS PER SECTION 35 & 20, SUBD. 7A M.D.L. & DEPT. RULES & REGULATIONS.
- 10. B.S.A. APPROVED PEEPHOLES APPROXIMATELY 5 FEET ABOVE FINISHED FLOOR TO BE PROVIDED IN ENTRANCE DOORS OF DWELLING UNITS AS PER SECTION D26-20.01 H.M.C. & DEPT. RULES & REGULATIONS.
- 11. PROPERLY MOUNTED & SECURED POLISHED METAL VIEWING MIRRORS TO BE PROVIDED WITH SELF SERVICE ELEVATORS (IF ANY) AS PER SECTION D26-20.03 H.M.C. & DEPT. RULES & REGULATIONS.
- 12. KEY LOCKS IN THE ENTRANCE DOORS OF EACH DWELLING UNIT WITH AT LEAST ONE KEY TO BE PROVIDED BY OWNER AS PER SECTION D26-20.05 H.M.C. HEAVY DUTY LATCH SET DEAD BOLT THUMB TURN INSIDE.
- 13. APPROVED TYPE MAIL RECEPTACLES & DIRECTORY OF PERSONS LIVING IN THE DWELLING TO BE PROVIDED BY OWNER AS PER SECTION D26-12.01 H.M.C. & REGULATIONS OF THE POST OFFICE DEPT. & SECTION 57 M.D.L.
- 14. PROPER FLOOR SIGNS TO BE PROVIDED IN PUBLIC HALL NEAR STAIRS & ELEVATOR WITHIN STAIR ENCLOSURE AS PER SECTION D26-21.03 H.M.C. & DEPT. RULES & REGULATIONS.
- 15. PROPER STREET NUMBER TO BE PROVIDED IN FRONT ON DWELLING AS PER SECTION 82(3)-1.0 ADMIN. CODE, SEC. D26-21.05 H.M.C. & RULES & REGULATIONS OF BOROUGH PRESIDENT.
- 16. PROPER JANITORIAL SERVICES TO BE PROVIDED AS PER SECTION D26-22.03 & D26-22.5 H.M.C.
- 17. EVERY KITCHEN & KITCHENETTE TO BE PROVIDED WITH SINK HAVING MINIMUM 2" WASTE & TRAP PER SECTION D26-32.01 H.M.C.
- 18. ALL COMBUSTIBLE MATERIAL WITHIN ONE FOOT OF COOKING APPARATUS TO BE PROPERLY FIRE RETARDED & MINIMUM 2 FOOT CLEARANCE MAINTAINED ABOVE EXPOSED COOKING SURFACE. COMBUSTIBILE MATERIAL BETWEEN 2' & 3' ABOVE EXPOSED SURFACE TO BE FIRE RETARDED. SECTION D26-32.05 H.M.C. & DEPT. RULES & REGULATIONS, SEC. 33, SUBD. 3 M.D.L.

EXISTING CERTIFICATE OF OCCUPANCY: #173454 DATED DEC 8, 1960 FOR FACTORY AND GARAGE FOR 4 MOTOR VEHICLES

CONSTRUCTION CLASSIFICATION: CLASS 3 NON-FIRE PROOF CONSTRUCTION PER 1938 CODE

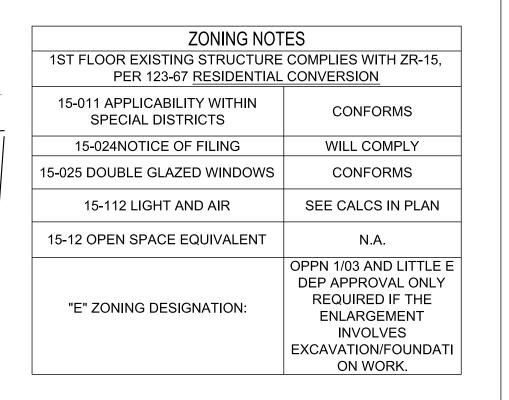

19. NO KITCHEN SHALL BE OCCUPIED FOR SLEEPING PURPOSES SEC. D26-23.05

- 20. REGISTRATION STATEMENT TO BE FILED AS PER SECTION D26-41.01 & D26-41.03 H.M.C.
- 21. REGISTRATION IDENTIFICATION SIGN CONTAINING DWELLING SERIAL NUMBER TO BE POSTED AS PER SECTION D26-41.15 H.M.C.
- 22. INDENTIFICATION OF MANAGING AGENT OR OWNER TO BE INDICATED ON TENANTS RECEIPT AS PER SECTION D26-41.17 H.M.C.
- 23. ALL BATHSROOMS, TOILETS & BATHING COMPARTMENTS TO HAVE CERAMIC TILE FLOOR & 6" MINIMUM CERAMIC TILE BASE WALLS & CEILINGS PLASTER AS PER SECTION D26-31.03 H.M.C.
- 24. ALL DOORS LEADING TO PUBLIC HALLS SHALL BE SELF CLOSING. NO TRANSOMS OR PLAIN GLASS PANELS.
- 25. BUILDING TO COMPLY WITH SECTION 64 M.D.L. GAS METERS, GAS APPLIANCES & ARTIFICIAL LIGHTING.
- 26. BUILDING TO COMPLY WITH SECTION D26-33.03 H.M.C. MAXIMUM OCCUPANCY MIN. ROOM AREA, ART. 33, D26-33.01 SUBD. B & E.
- 27. ENTIRE BUILDING TO COMPLY WITH LOCAL LAWS APPLICABLE TO ART. 6 WITH H.M.C. & DEPT. RULES & REGULATIONS.
- 28. ALL NEWLY CREATED PARTITIONS IN HALLS TO BE FIRE RETARDED ON BOTH SIDES & FIRE STOPPED AT TOP & BOTTOM AS PER DEPT. RULES & REGULATIONS, RULE 1.2.10 & RULE 1.7.

ZONI	NG NOTES (CONT.)			
SINGLE STORY ADDITION ON SECO ZR-77 FOR MI	ND LEVEL COMPLIES WITI XED R6A AND MX-8 DISTR			
TOTAL EXISTING LOT AREA	24.9 x ±101 =	2526 sf		
LOT AREA IN MX-8, MI-2/R6A	24.9 x ±90 =	2255 sf		
LOT AREA IN R6A/C2-4 OVERLAY	24.9 x ±11	271 sf		
REQD. MAX FLOOR AREA IN MX-8, MI-2/R6A (23-144, 23-942, 123-63)	2255 x 2.7 =	6088 sf		
REQD. MAX FLOOR AREA IN R6A/C2-4 OVERLAY (23-144, 23-942, 123-63)	271sf x 2.7 =	731 sf		
TOTAL REQ'D MAX FLOOR AREA	6088 + 731 =	6819 sf		
EXISTING FLOOR AREA	24.9 X ±101 =	2526 sf		
PROPOSED FLOOR AREA OF NEW ADDITION	24.9 X 50	1245 sf		
PROPOSED TOTAL FLOOR AREA	(24.9 X 101 EXIST.) + (24.9 X 50 PROPOSED) =	3783 sf		
REQD. MAX LOT COVERAGE IN MX-8, MI-2/R6A (23-145, 123-63, 77-24)	2255 X 0.60 =	1353 sf		
REQD. MAX LOT COVERAGE IN R6A/C2-4 OVERLAY (23-145, 123-63, 77-24)	271 x 0.60 =	163 sf		
TOTAL REQ'D MAX LOT COVERAGE	1344 + 171 =	1516 sf		
PROPOSED LOT COVERAGE, RESIDENTIAL CONVERSION, NON-COMPLYING CONVERSION (123-67, 54-31)	24.9 X ±101 =	2526 sf		
REQD. REAR YD. (123-67, ZR-15, 54-31)	SEE NOTES ON LEFT - RESIDENTIAL CONVERSION	0' EXIST. ON 1ST FLR TO REMAIN		
PROPOSED REAR SETBACK OF NEW 2ND STORY ADDITION		AR LOT LINE OR 40'-43' RICT BOUNDARY		
REQD. SIDEYARD, ZR123-651	NONE IN SPECIAL MIXED USE DISTRICTS & FOR SINGLE-FAM	0' IN EXISTG. BLDG, 0' IN PROPOSED ADDITION WHICH IS WHOLLY IN MX-8		
REQD. MAX # D.U. 23-22	2526 X 2.7 / 680 =	10		
PROPOSED # D.U.		1		
ACCESSORY OFF-STREET PARKING (123-72)	1 PER DWELLING UNIT REQ'D.	1 EXIST'G. PARKING SPACE PROVIDED		
ACCESSORY OFF-STREET BICYCLE PARKING (25-80)	1 PER 2 D.U. (WAIVED FOR 10 D.U. OR LESS)	N/A - LESS THAN 10 D.U.		
REQD. MAX HEIGHT/SET BACK (23-662, 77-28)	MAX BASE 60', MAX HEIGHT 70'	PROPOSED HEIGHT 28', NO SETBACK		
MIN. REQ'D LOT AREA FOR RESIDENTIAL (23-32, 123.61)	1700 MIN. LOT AREA, 18' MIN. LOT WIDTH REQ'D.	2526 sf LOT AREA, 24.9'		
REQD. USE, 77-11, 123-20	ALL USES PERMITTED IN DESIGNATED			
PROPOSED USE	RESIDENTIAL DISTRICT R6A PERMITTED 1 UNIT OF 'GENERAL' RESIDENCE, USE GROUP 2			
		ALL PROVIDE 35Db(A) OF		
REQD. ENVIRONMENTAL CONDITIONS 123-32	ATTENUATION, ALT			
STREET TREES 28-03, 123-61, NY	50% PROPOSED INCREAS RE'QD: 1 TREE PER 2	SE IN FLOOR AREA > 20% 5' FRONTAGE REQ'D.		
TREE PLANTING STANDARDS		IGHT POST & CURB CUT, ED (SEE SITEPLAN, A-001)		
REQ'D MINIMUM D.U. 28-21		SF		
PROPOSED MINIMUM D.U.	3783 sf > 400 S	SF , COMPLIES		
WINDOWS 28-22		BE DOUBLE-GLAZED AS JIRED		
REFUSE STORAGE 28-23		THAN 9 D.U.		
DECDEATION SPACE 29 21	N/A LESS:			

FIRE-RATING SUMMARY (TABLE 3-4) CONSTRUCTION CLASS I-C (2-hr PROTECTED), OCCUPANCY GROUP J-3 EXTERIOR BEARING WALLS @ LOT LINE 2 HR EXTERIOR NON-LOAD BEARING WALLS @ FACADE AND REAR OVER 30' SEPARATION N.L. INTERIOR BEARING WALLS & PARTITIONS 2 HR COLUMNS SUPPORTING MORE THAN ONE FLOOR 2 HR FLOOR CONSTRUCTION 1½ HR ROOF CONSTRUCTION 1 HR

RECREATION SPACE 28-31

N/A - LESS THAN 9 D.U

ABBREVIATIONS SYMBOLS:

ADD'L additional	
AFF above finished floor (101) = DOOR # AHU air handling unit ANOD. anodized	
B.O. by others CAB. cabinet CEIL'G. ceiling CL center line CLR. clear	
CMU concrete masonry unit C.O. cleanout - 10'-0" = CEILING HGT. AFF COL. column	
CONC. concrete C.P. compactor D. dryer = INTERIOR ELEVATI DWG. # / SHEET	ON
DBL. double DIA. diameter DIR. direction	
DN down DR. door D.W. dishwasher = NEW INTERIOR PAR	RTITION
DWG. drawing = 2-HR RATED WALI	_
ELEV. elevation EQ. equal = EXIST. INTERIOR P EQUIP. equipment TO REMAIN	ARTITION
EXIST. existing = EXIST. INTERIOR P EXT. exterior = EXIST. INTERIOR P FF finished floor TO BE DEMOLISHED	
FIN. finished FIXT. fixture FLR. floor FLUOR. flourescent FDN. foundation GEN. general GWB gypsum wall board)" × 48"
HVAC heat / vent / air-condition HC handicap INSUL. insulation = APPD. TYPE COMB	INATION

(CO/S)

LOC.

MAX.

MIN.

0.C.

P.T.

REG.

R.O.

RM

RR

SIM.

SOF.

SS

STL.

T.B.D.

T&G

THK.

T.O. T.R.

TYP.

U.S.

VCT

WD.

VERT.

SPEC.

REINF.

PT'D.

location / locate

low-voltage

maximum

minimum

microwave

not to scale

pressure treated

mounted

on center

painted

register

reinforce

гоот

soffit

steel tread

top of to remain

typical

vertical

wood

WNDW. window

underside

verify in field

water closet

Z.C.C zinc-coated copper

washing machine

similar

rough opening

roof rafters

specification

stainless steel

to be determined

tongue in groove

thick / thickness

unless noted otherwise

vinyl composition tile

QTY. quantity

REQ'D. required

= APPD. TYPE COMBINATION SMOKE DETECTOR (PER LL62/81) & CARBON MONOXIDE DETECTOR (PER LL

HSU HOUSE

94 N. 1st STREET BROOKLYN, NY

DRAWING LIST:

A000	COVER SHEET
	SURVEY
	RESCHECK COMPLIANCE CERTIFICATE
A001	SITE PLAN
D101	DEMO PLAN

NEW WORK ROOF PLAN/ PLUMBING RISER DIAGRAM/ GAS RISER DIAGRAM

NEW WORK PLAN

A201 SECTIONS/ELEVATIONS
A202 INTERIOR ELEVATIONS

A202 INTERIOR ELEVATIONS
A401 WALL SECTIONS
S101 STRUCTURAL PLANS

S102 STRUCTURAL PLANS/ SECTION E001 ENERGY COMPLIANCE REPORT **S** s **D**

262 W 38TH STREET, SUITE 1504 NEW YORK, NY 10018

tel: 212, 248, 7500 fax: 866, 677, 3878 www.ssdarchitecture.com info@ssdarchitecture.com

CONSULTANTS:

STRUCTURAL ENGINEER: Richard H. Balser, Engineers 228 W 18th Street, No. 11 New York, NY 10011 T 212-463-0008

MEP ENGINEER: T.W.I.G. Inc. 7 Penn Plaza - Suite 1003 New York, NY 10001

T 212.967.8944 F 212.967.8945

SURVEYOR:
Leonard J. Strandberg and Associates
Consulting Engineers and
Land Surveyors, P.C.
92 Atlantic Avenue, Freeport, NY 11520
516-378-2064 212-213-4090
fax 516-378-6649

HSU HOUSE

PROJECT ADDRESS:

94 NORTH FIRST STREET
BROOKLYN, NY 11211

DWG TITLE:
TITLE PAGE

SEAL & SIGNATURE:

DATE: 09 MAR 2012


PROJECT No.: 0913


DWG BY: WW, FPO, SK, PV, JH , JC

DWG No.: A-000.01


CHK BY: JH, JP

PAGE No

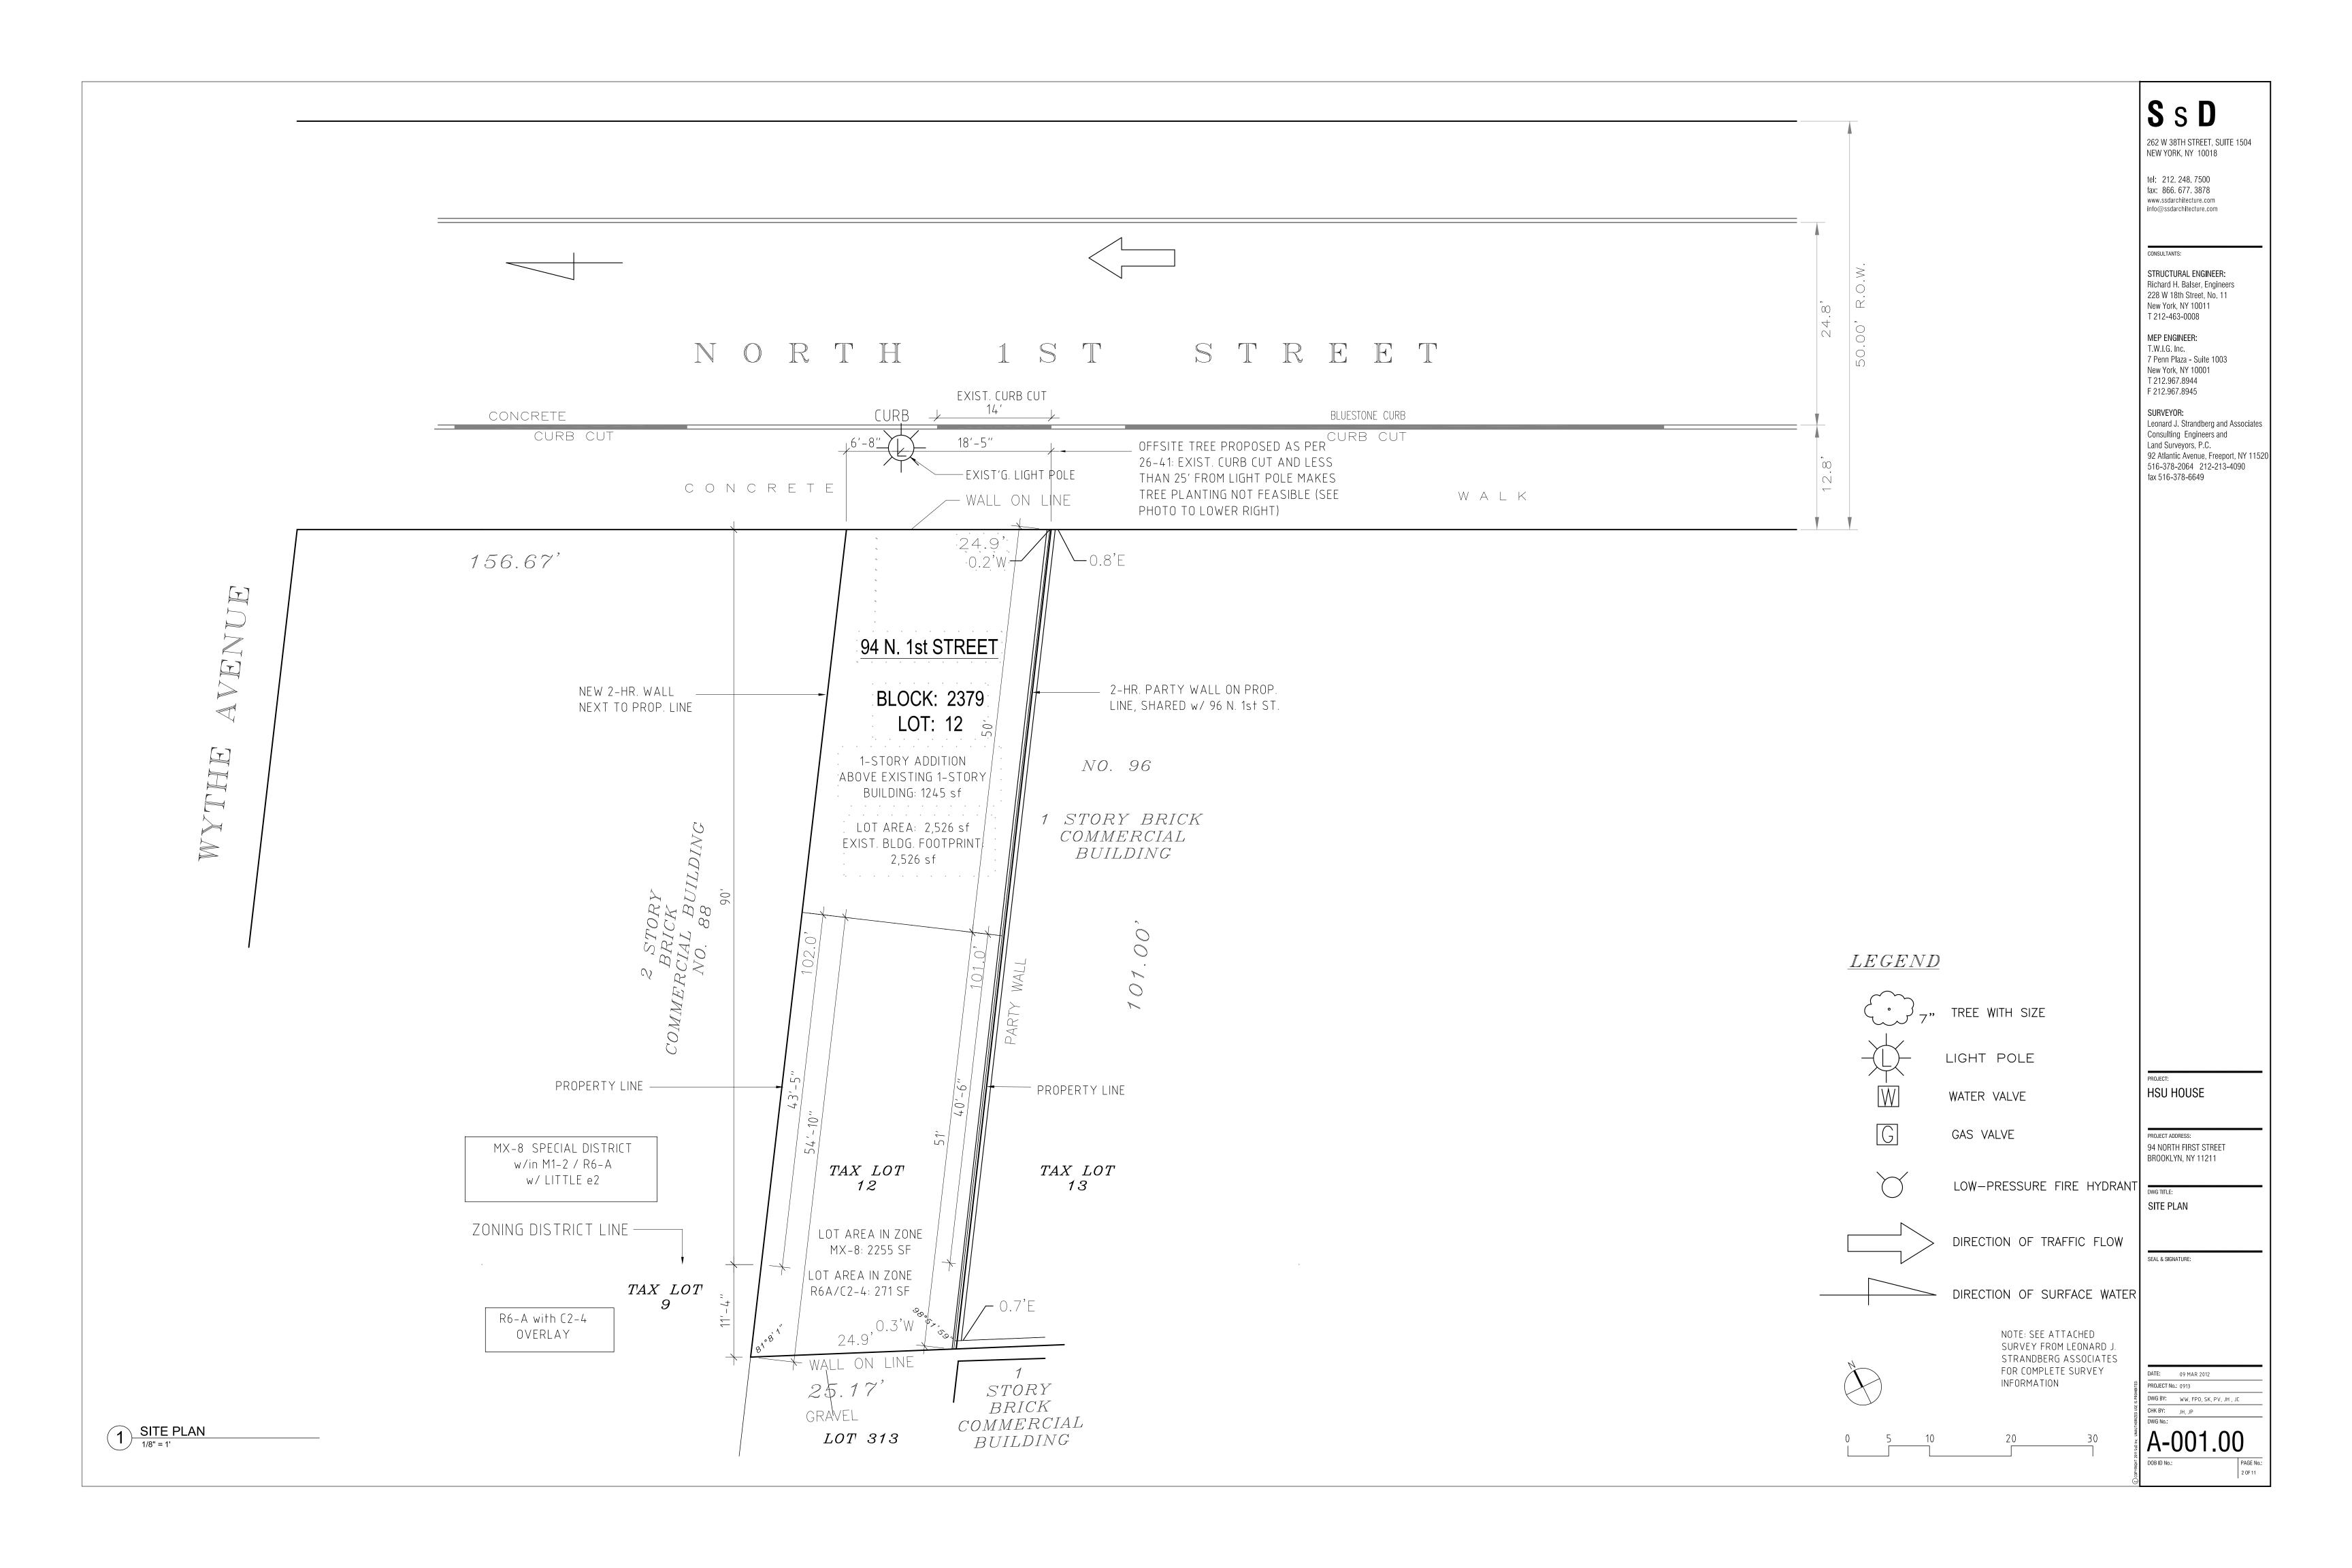

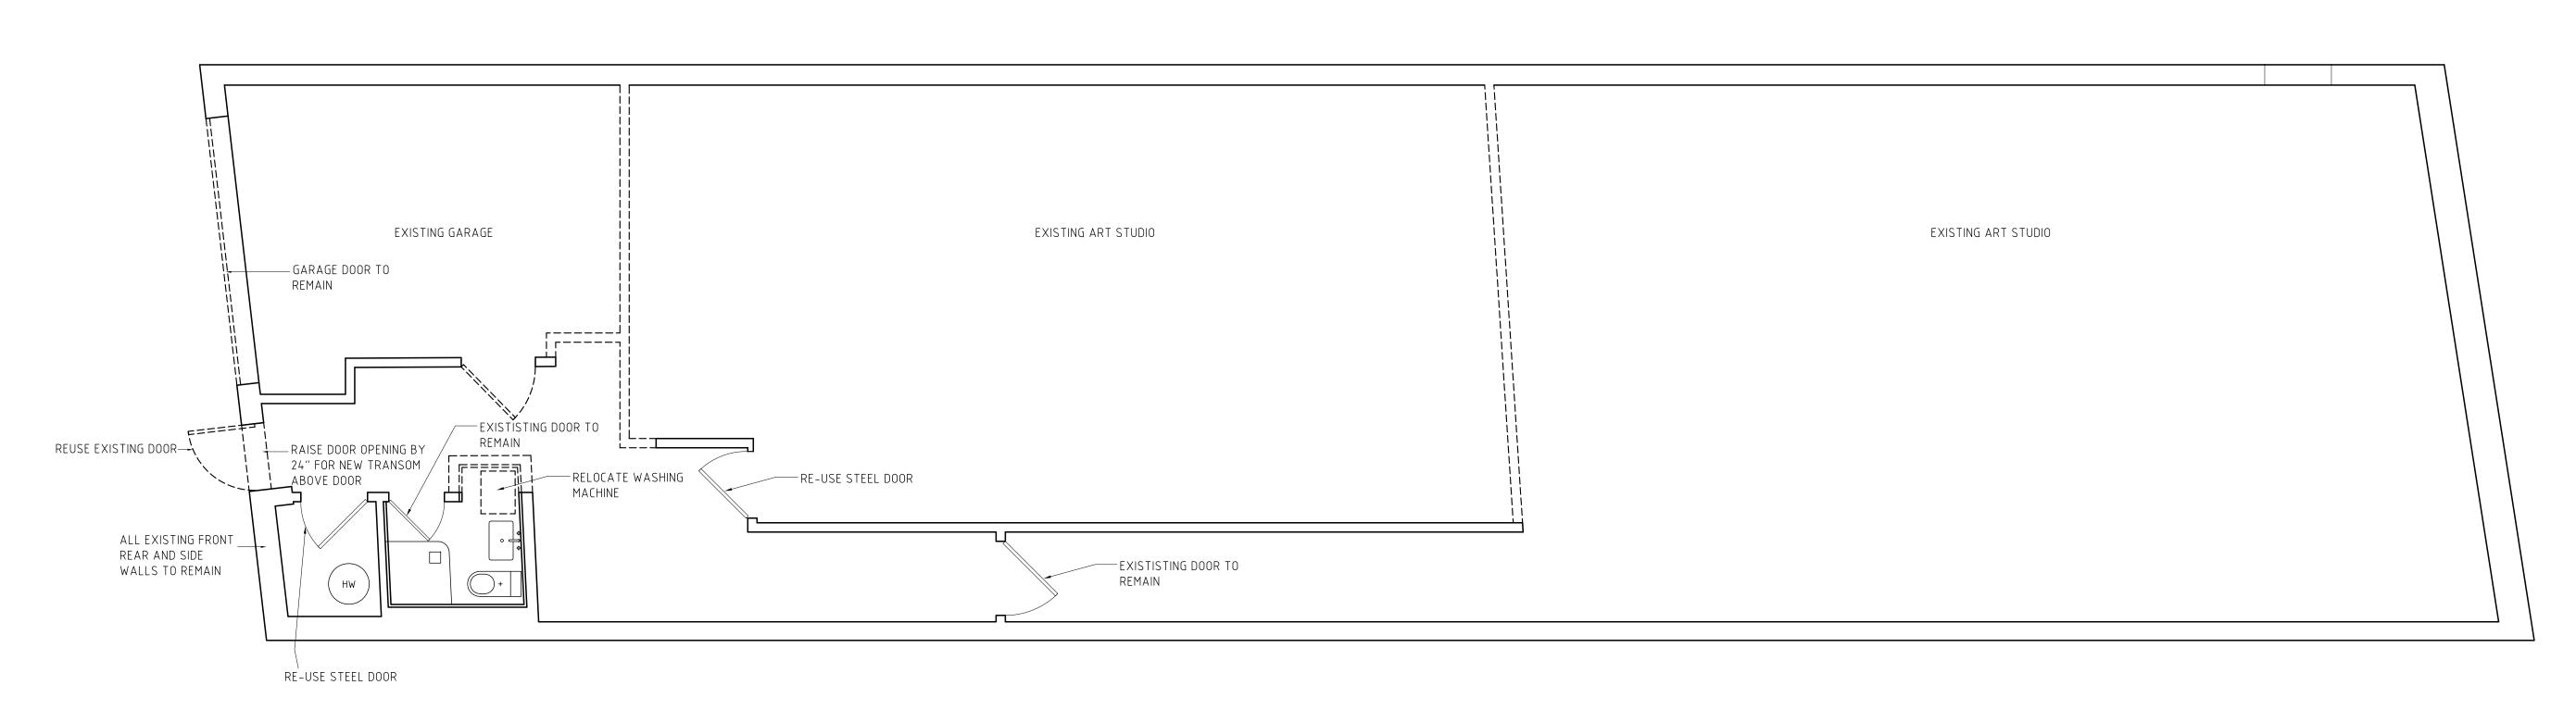

1 1ST FLOOR DEMO PLAN
1/4" = 1'

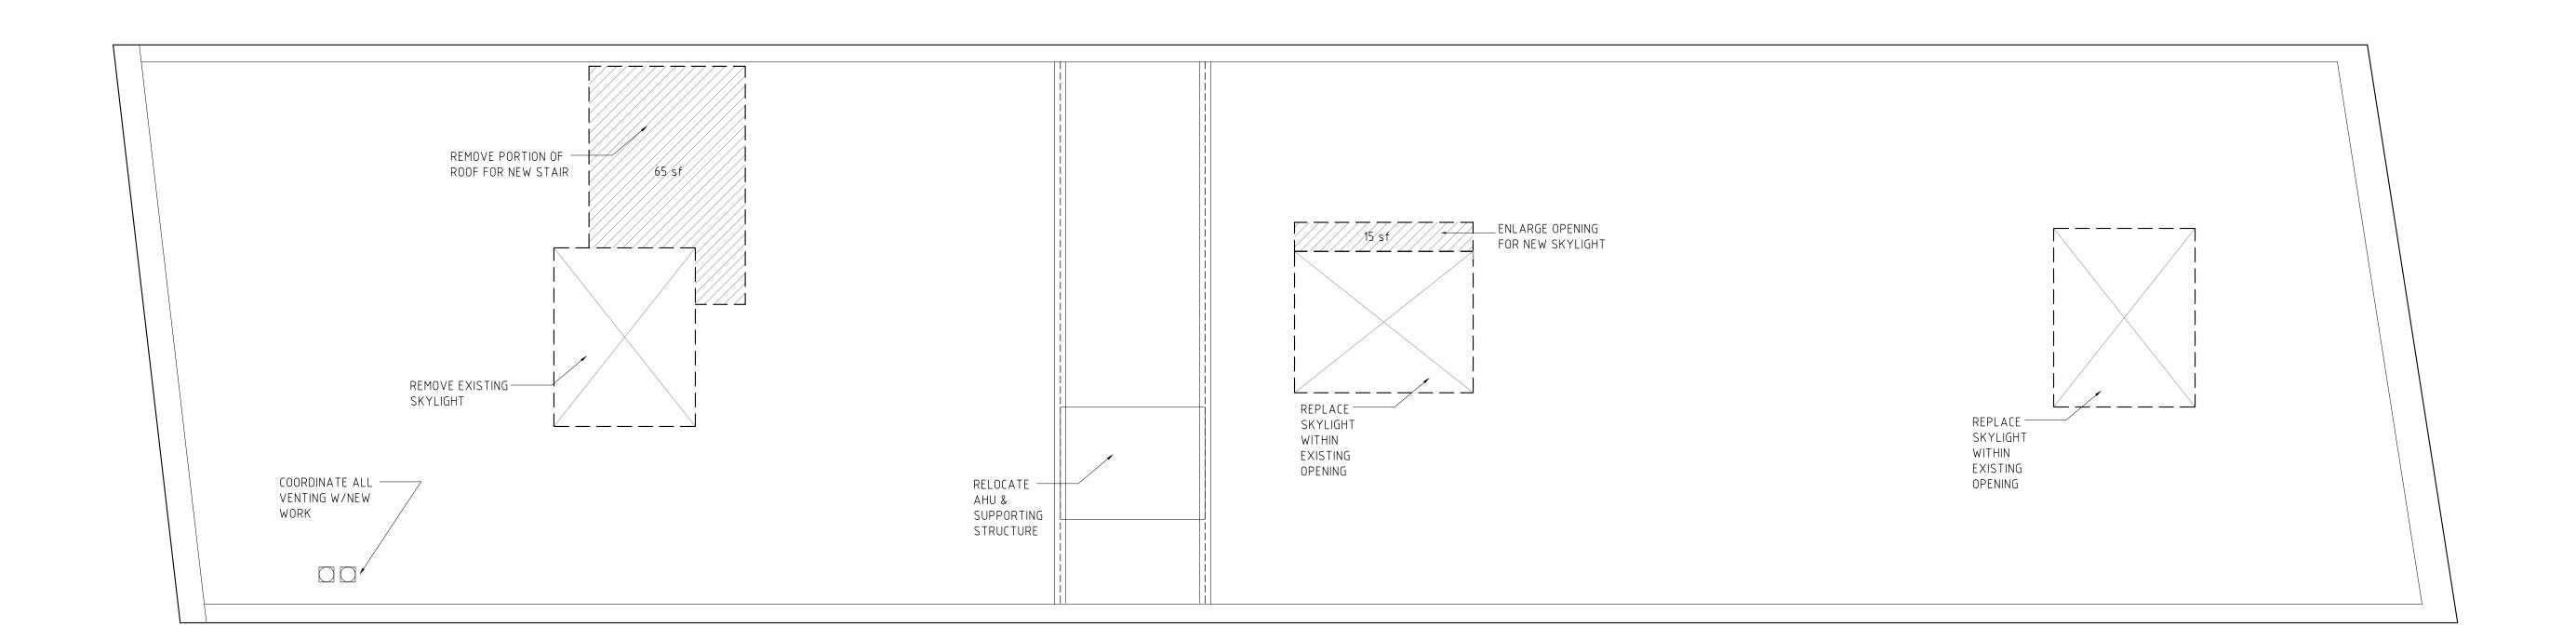

AREA CALCULATIONS OF EXTERIOR WALLS/ROOF TO BE REMOVED					
	EXISTING AREA	AREA TO BE REMOVED	% REMOVED		
FRONT WALL	24.9 x 15.5 = 386sf	3.2 x 2 = 7sf	2%		
REAR WALL	24.9 x 15.5 = 386sf	0sf	0%		
SIDE WALL WEST	102 x 15.5 = 1581sf	0sf	0%		
SIDE WALL EAST	101 x 15.5 = 1581sf	0sf	0%		
ROOF	24.9 X 101 = 2526sf	80sf	3%		
TOTAL	6450sf	87sf	1.3%		



SURFACES TO BE REMOVED

<u>DEMO NOTES</u>

- ALL DEMO WORK TO BE COORDINATED W/ LICENSED PLUMBER & ELECTRICIAN.
 PROTECT ALL AREAS THAT ARE NOT TO
- 3. PATCH/REPAIR ALL AREAS EXPOSED BY
- DEMO WORK THAT WILL NOT BE
- COMPLETELY HIDDEN BY NEW WORK.
- 4. NO CHIPPING/CHANNELING OF UNDERLYING STRUCTURAL/ FIRE-RATED MATERIALS

DWG BY: WW, FPO, SK, PV, JH, JC
CHK BY: JH, JP
DWG No.:

DATE: 09 MAR 2012

HSU HOUSE

SEAL & SIGNATURE:

94 NORTH FIRST STREET BROOKLYN, NY 11211

DEMO PLAN: 1ST FLR & ROOF

S s **D**

tel: 212.248.7500 fax: 866.677.3878

CONSULTANTS:

www.ssdarchitecture.com info@ssdarchitecture.com

STRUCTURAL ENGINEER: Richard H. Balser, Engineers

228 W 18th Street, No. 11

MEP ENGINEER: T.W.I.G. Inc. 7 Penn Plaza - Suite 1003 New York, NY 10001


Leonard J. Strandberg and Associates
Consulting Engineers and
Land Surveyors, P.C.
92 Atlantic Avenue, Freeport, NY 11520
516-378-2064 212-213-4090
fax 516-378-6649


T 212.967.8944 F 212.967.8945


SURVEYOR:


New York, NY 10011 T 212-463-0008

262 W 38TH STREET, SUITE 1504 NEW YORK, NY 10018

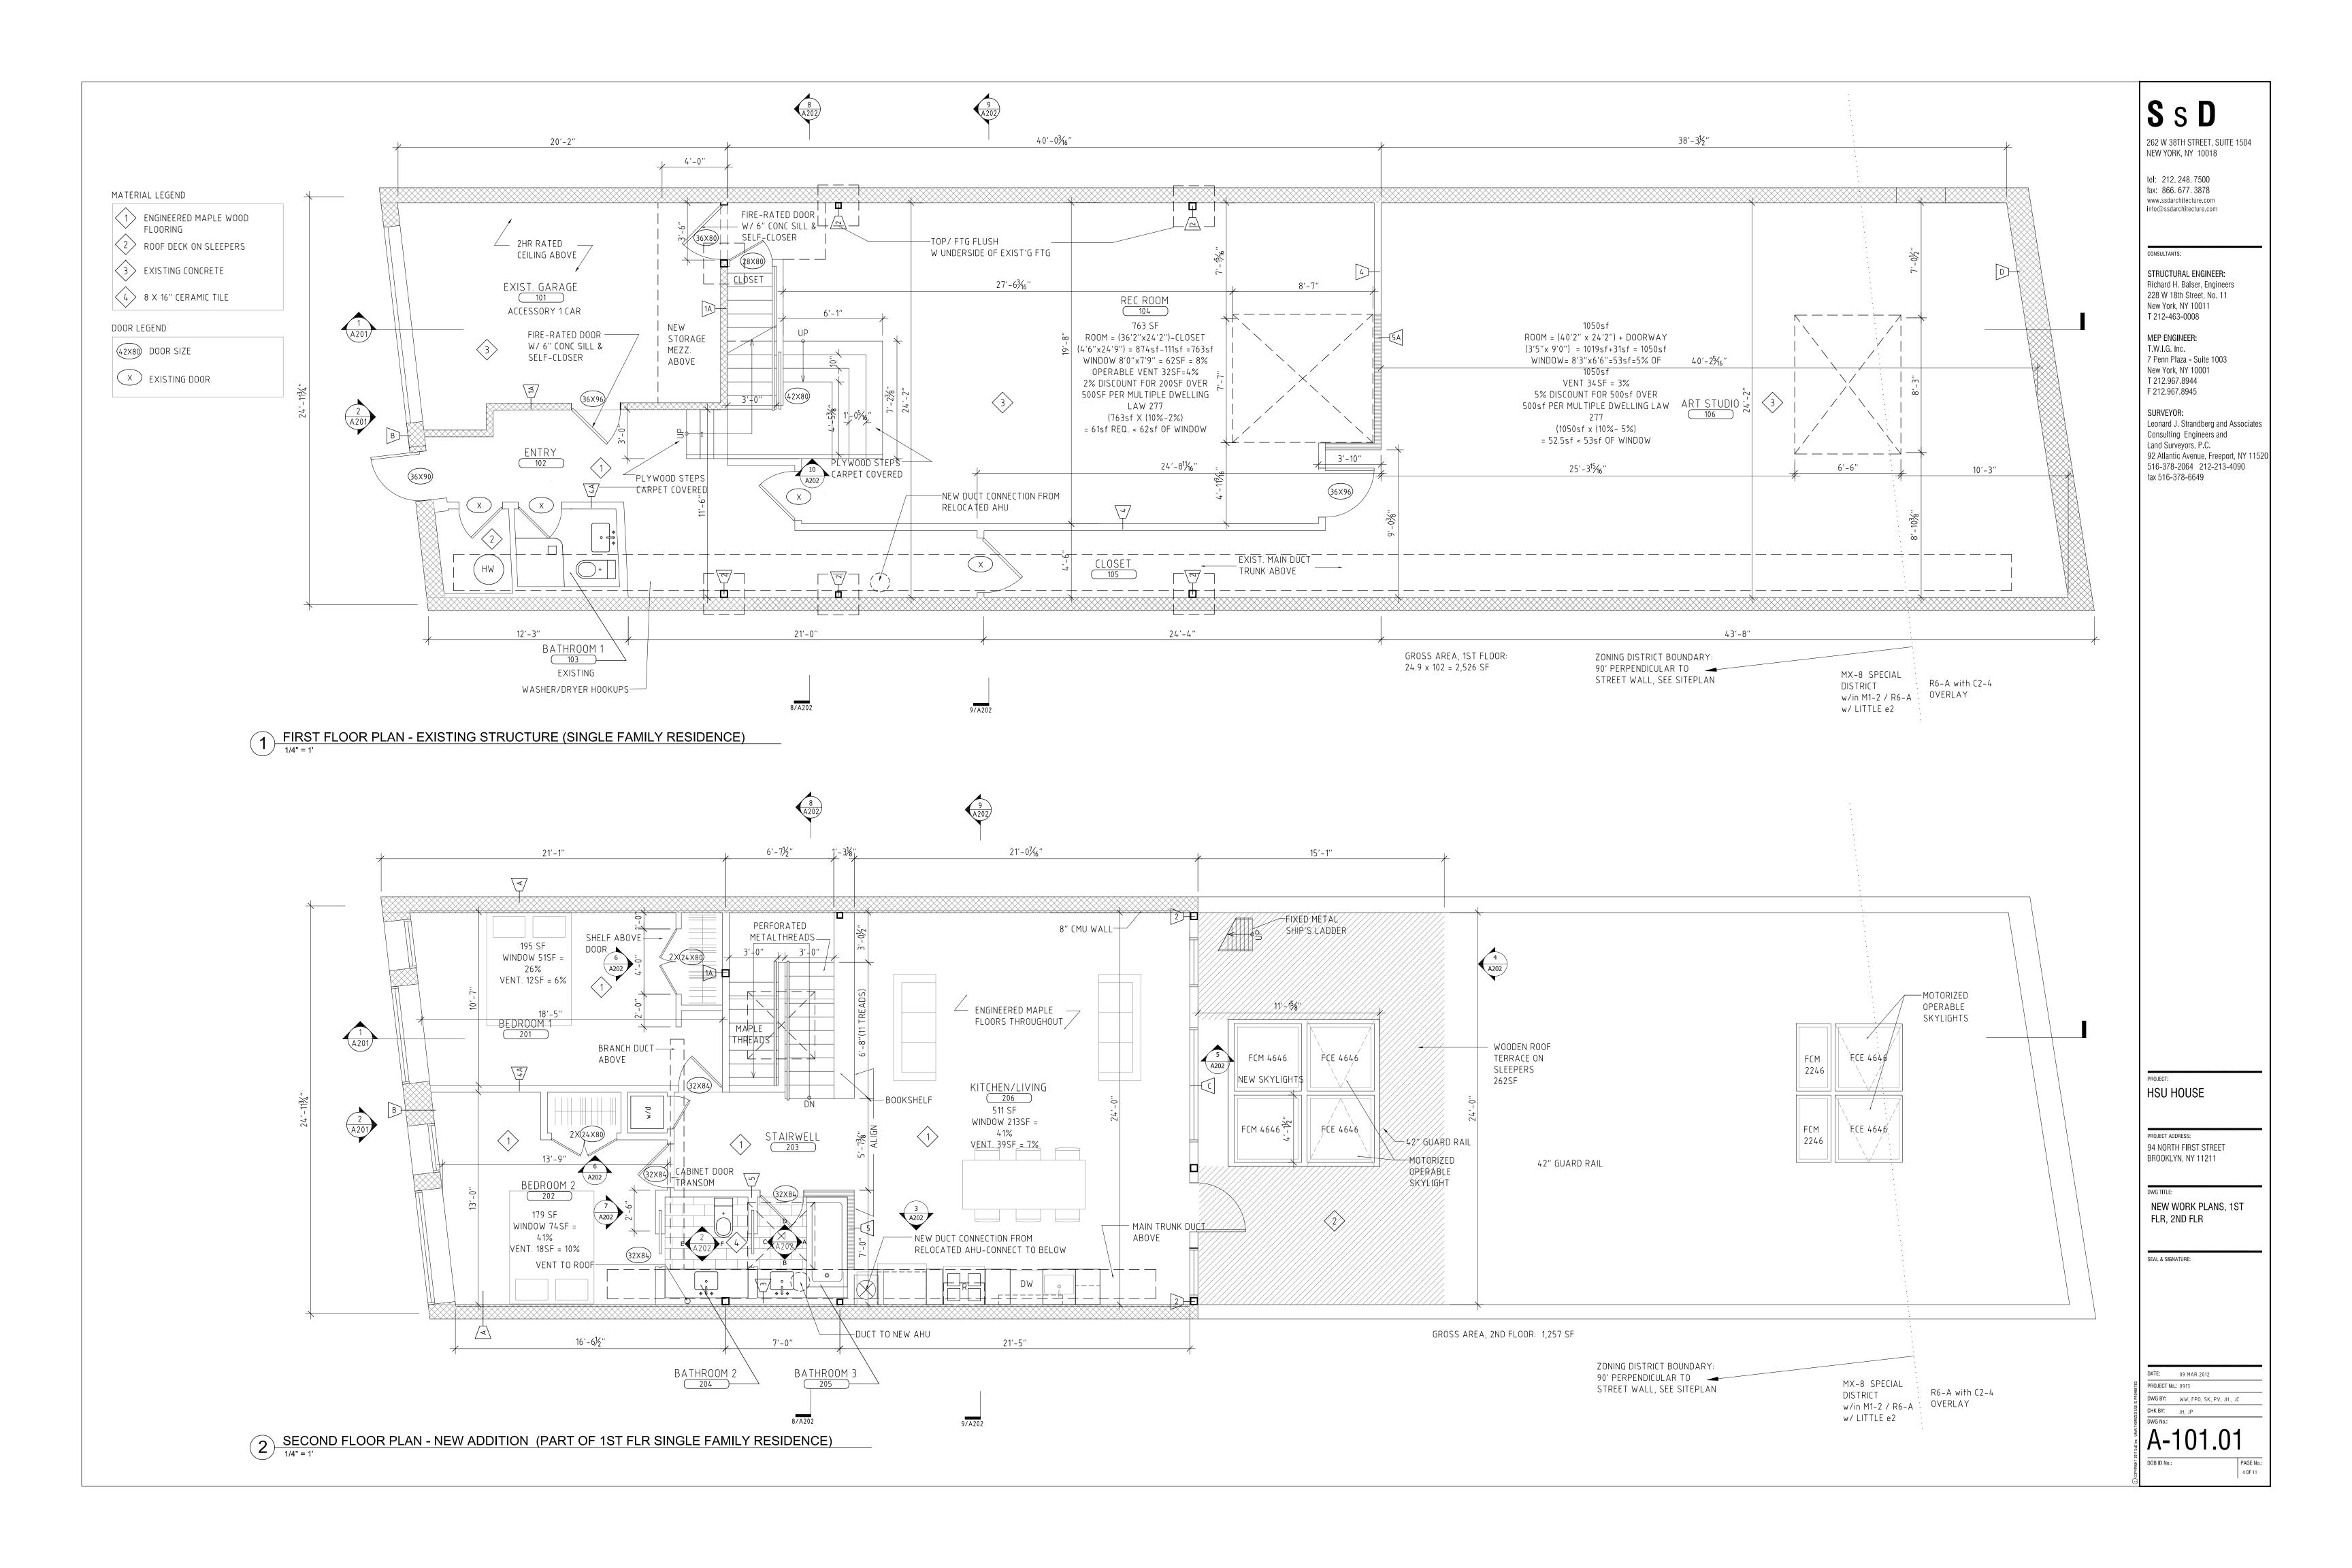

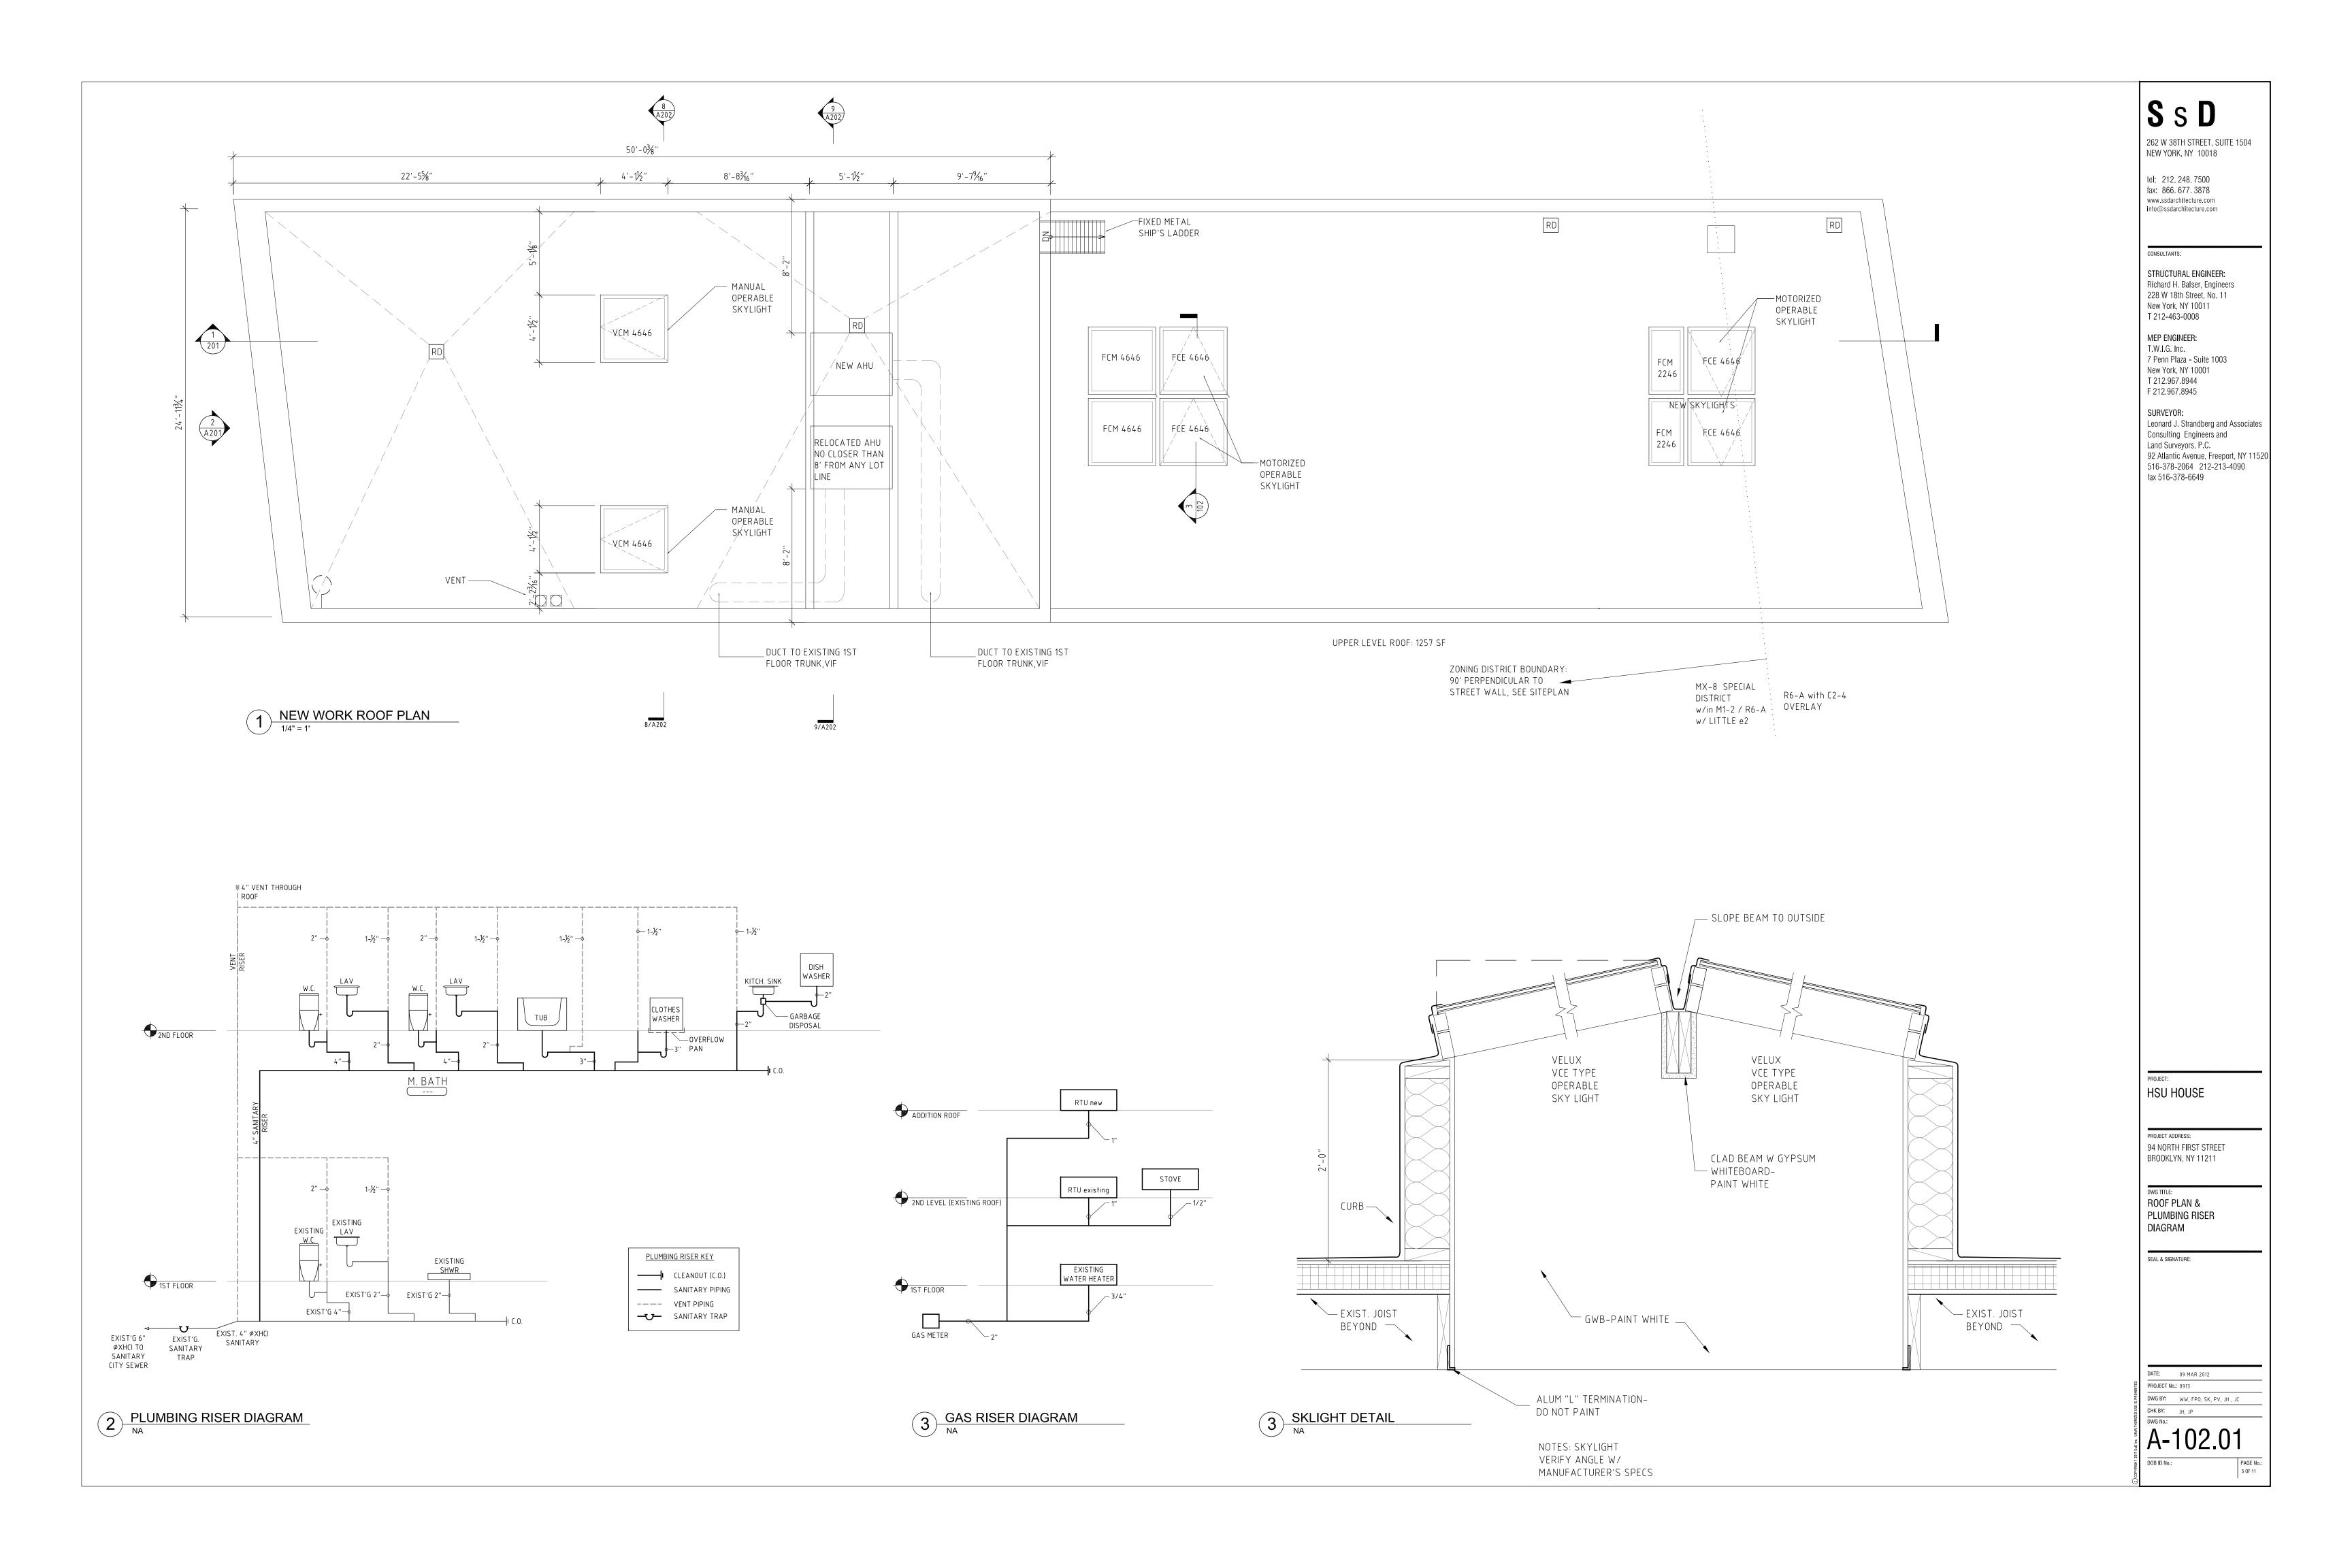

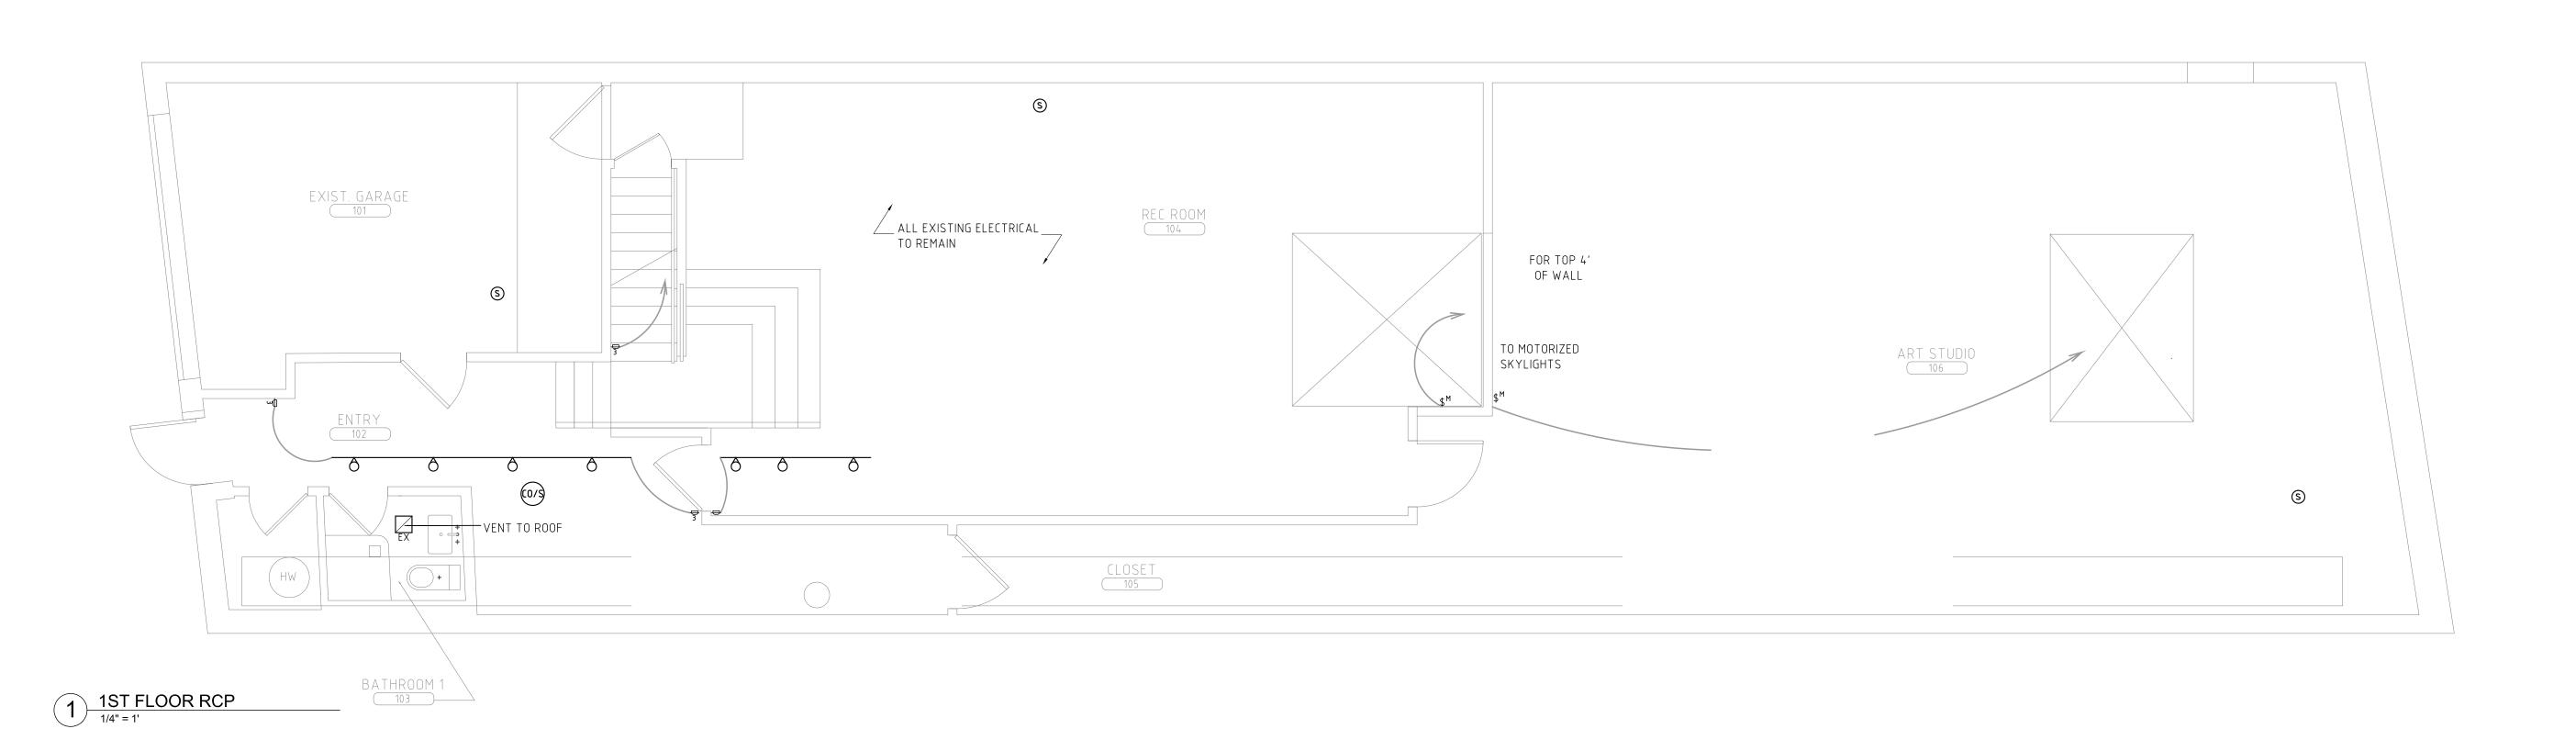

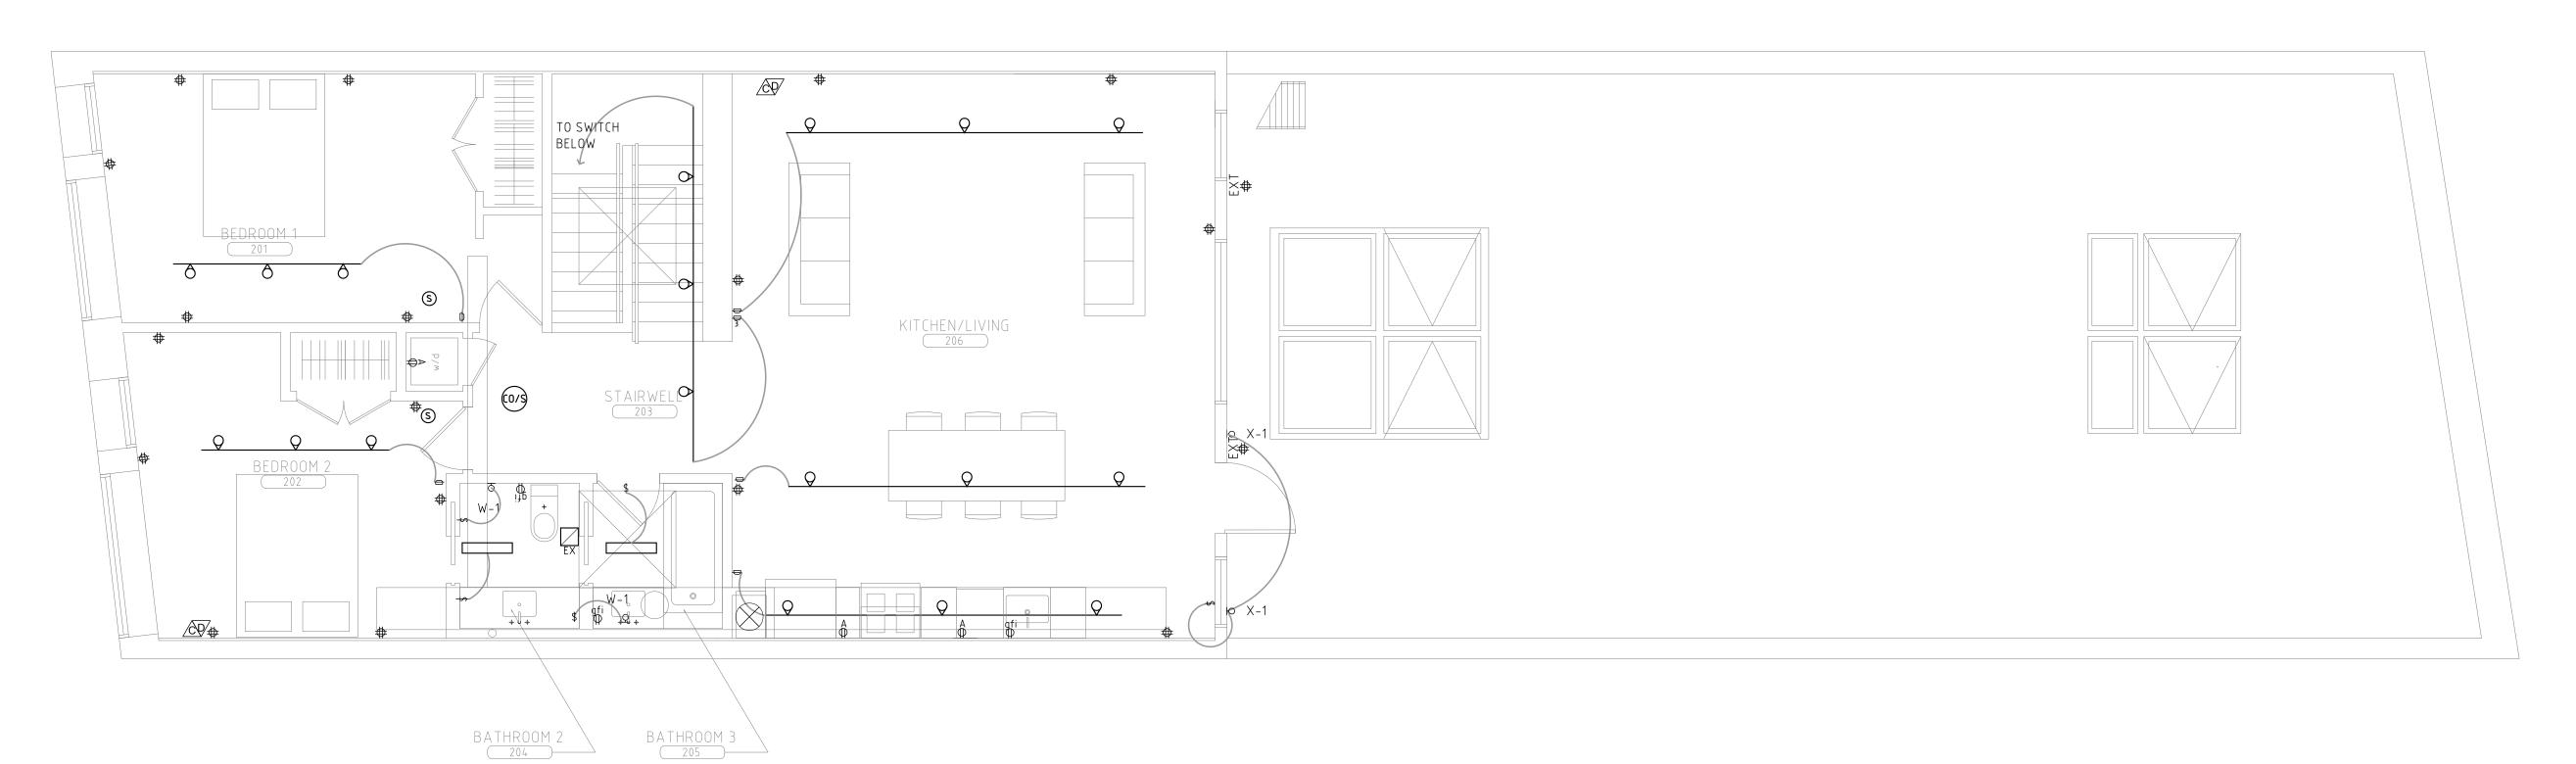

2ND FLOOR RCP
1/4" = 1'

RCP NOTES

1. ALL NEW OUTLETS & SWITCHES TO BE SPACED

- PER CODE. 2. ALL EXIST. FIRE SAFETY DEVICES TO REMAIN
- 3. MATCH ALL SWITCHES WITH TRANSFORMER OR FIXTURE TYPE.
- 4. NO CHOPPING OR CHANNELLING OF
- STRUCTURAL/FIRE-RATED MATERIALS 5. A LICENSED ELECTRICIAN SHALL PERFORM ALL ELECTRICAL WORK AND SECURE ALL APPROPRIATE PERMITS AND APPROVALS.

<u>DEVICES / EQUIPMENT</u>

×⇔ EXIST. DUPLEX OUTLET

🛕 CABLE TV JACK

- 😝 DUPLEX OUTLET GFI ∢⊜ APPLIANCE OUTLET - COORD. W/ EQUIPMENT
- \$ LUTRON 'DIVA' SWITCH SEE PLAN FOR TYPE
- D LUTRON 'DIVA' DIMMER ⚠ DATA/VOICE JACK

MECH EXHAUST VENT

S SMOKE DETECT (C) CARBON DIOXIDE DETECTOR

(CO/S) APPD. TYPE COMBINATION SMOKE DETECTOR (PER LL 62/81) & CARBON MONOXIDE DETECTOR (PER LL 7/04)

LIGHT FIXTURE SCHEDULE

SYMBOL	DESCRIPTION	MANUF. / FIXTURE	FINISH	BULB	NOTES
ð	LINE VOLTAGE TRACK HEAD	PROGRESS LIGHTING	WHITE FINISH	PR20	
	TRACK	PROGRESS LIGHTING	WHITE FINISH		
	CEIL'G HANGING	PROGRESS LIGHTING	BRUSHED NICKEL	1-17W T8FI	
₩-1	WALL LIGHT- VANITY	PROGRESS LIGHTING	CLEAR PRISMATIC	1-9W CF	
ЮX-1	WALL LIGHT- EXTERIOR	PROGRESS LIGHTING	CLEAR PRISMATIC	1-9W CF	

S s **D**

262 W 38TH STREET, SUITE 1504 NEW YORK, NY 10018

tel: 212.248.7500 fax: 866.677.3878 www.ssdarchitecture.com info@ssdarchitecture.com

STRUCTURAL ENGINEER: Richard H. Balser, Engineers 228 W 18th Street, No. 11 New York, NY 10011 T 212-463-0008

MEP ENGINEER: T.W.I.G. Inc. 7 Penn Plaza - Suite 1003 New York, NY 10001 T 212.967.8944 F 212.967.8945

SURVEYOR:

Leonard J. Strandberg and Associates
Consulting Engineers and
Land Surveyors, P.C.
92 Atlantic Avenue, Freeport, NY 11520
516-378-2064 212-213-4090
fax 516-378-6649

HSU HOUSE


PROJECT ADDRESS: 94 NORTH FIRST STREET BROOKLYN, NY 11211


SEAL & SIGNATURE:


REFLECTED CEILING PLANS, 1ST FLR, 2ND FLR


> DATE: 09 MAR 2012 DWG BY: WW, FPO, SK, PV, JH , JC CHK BY: JH, JP

PAGE No.: 6 OF 11

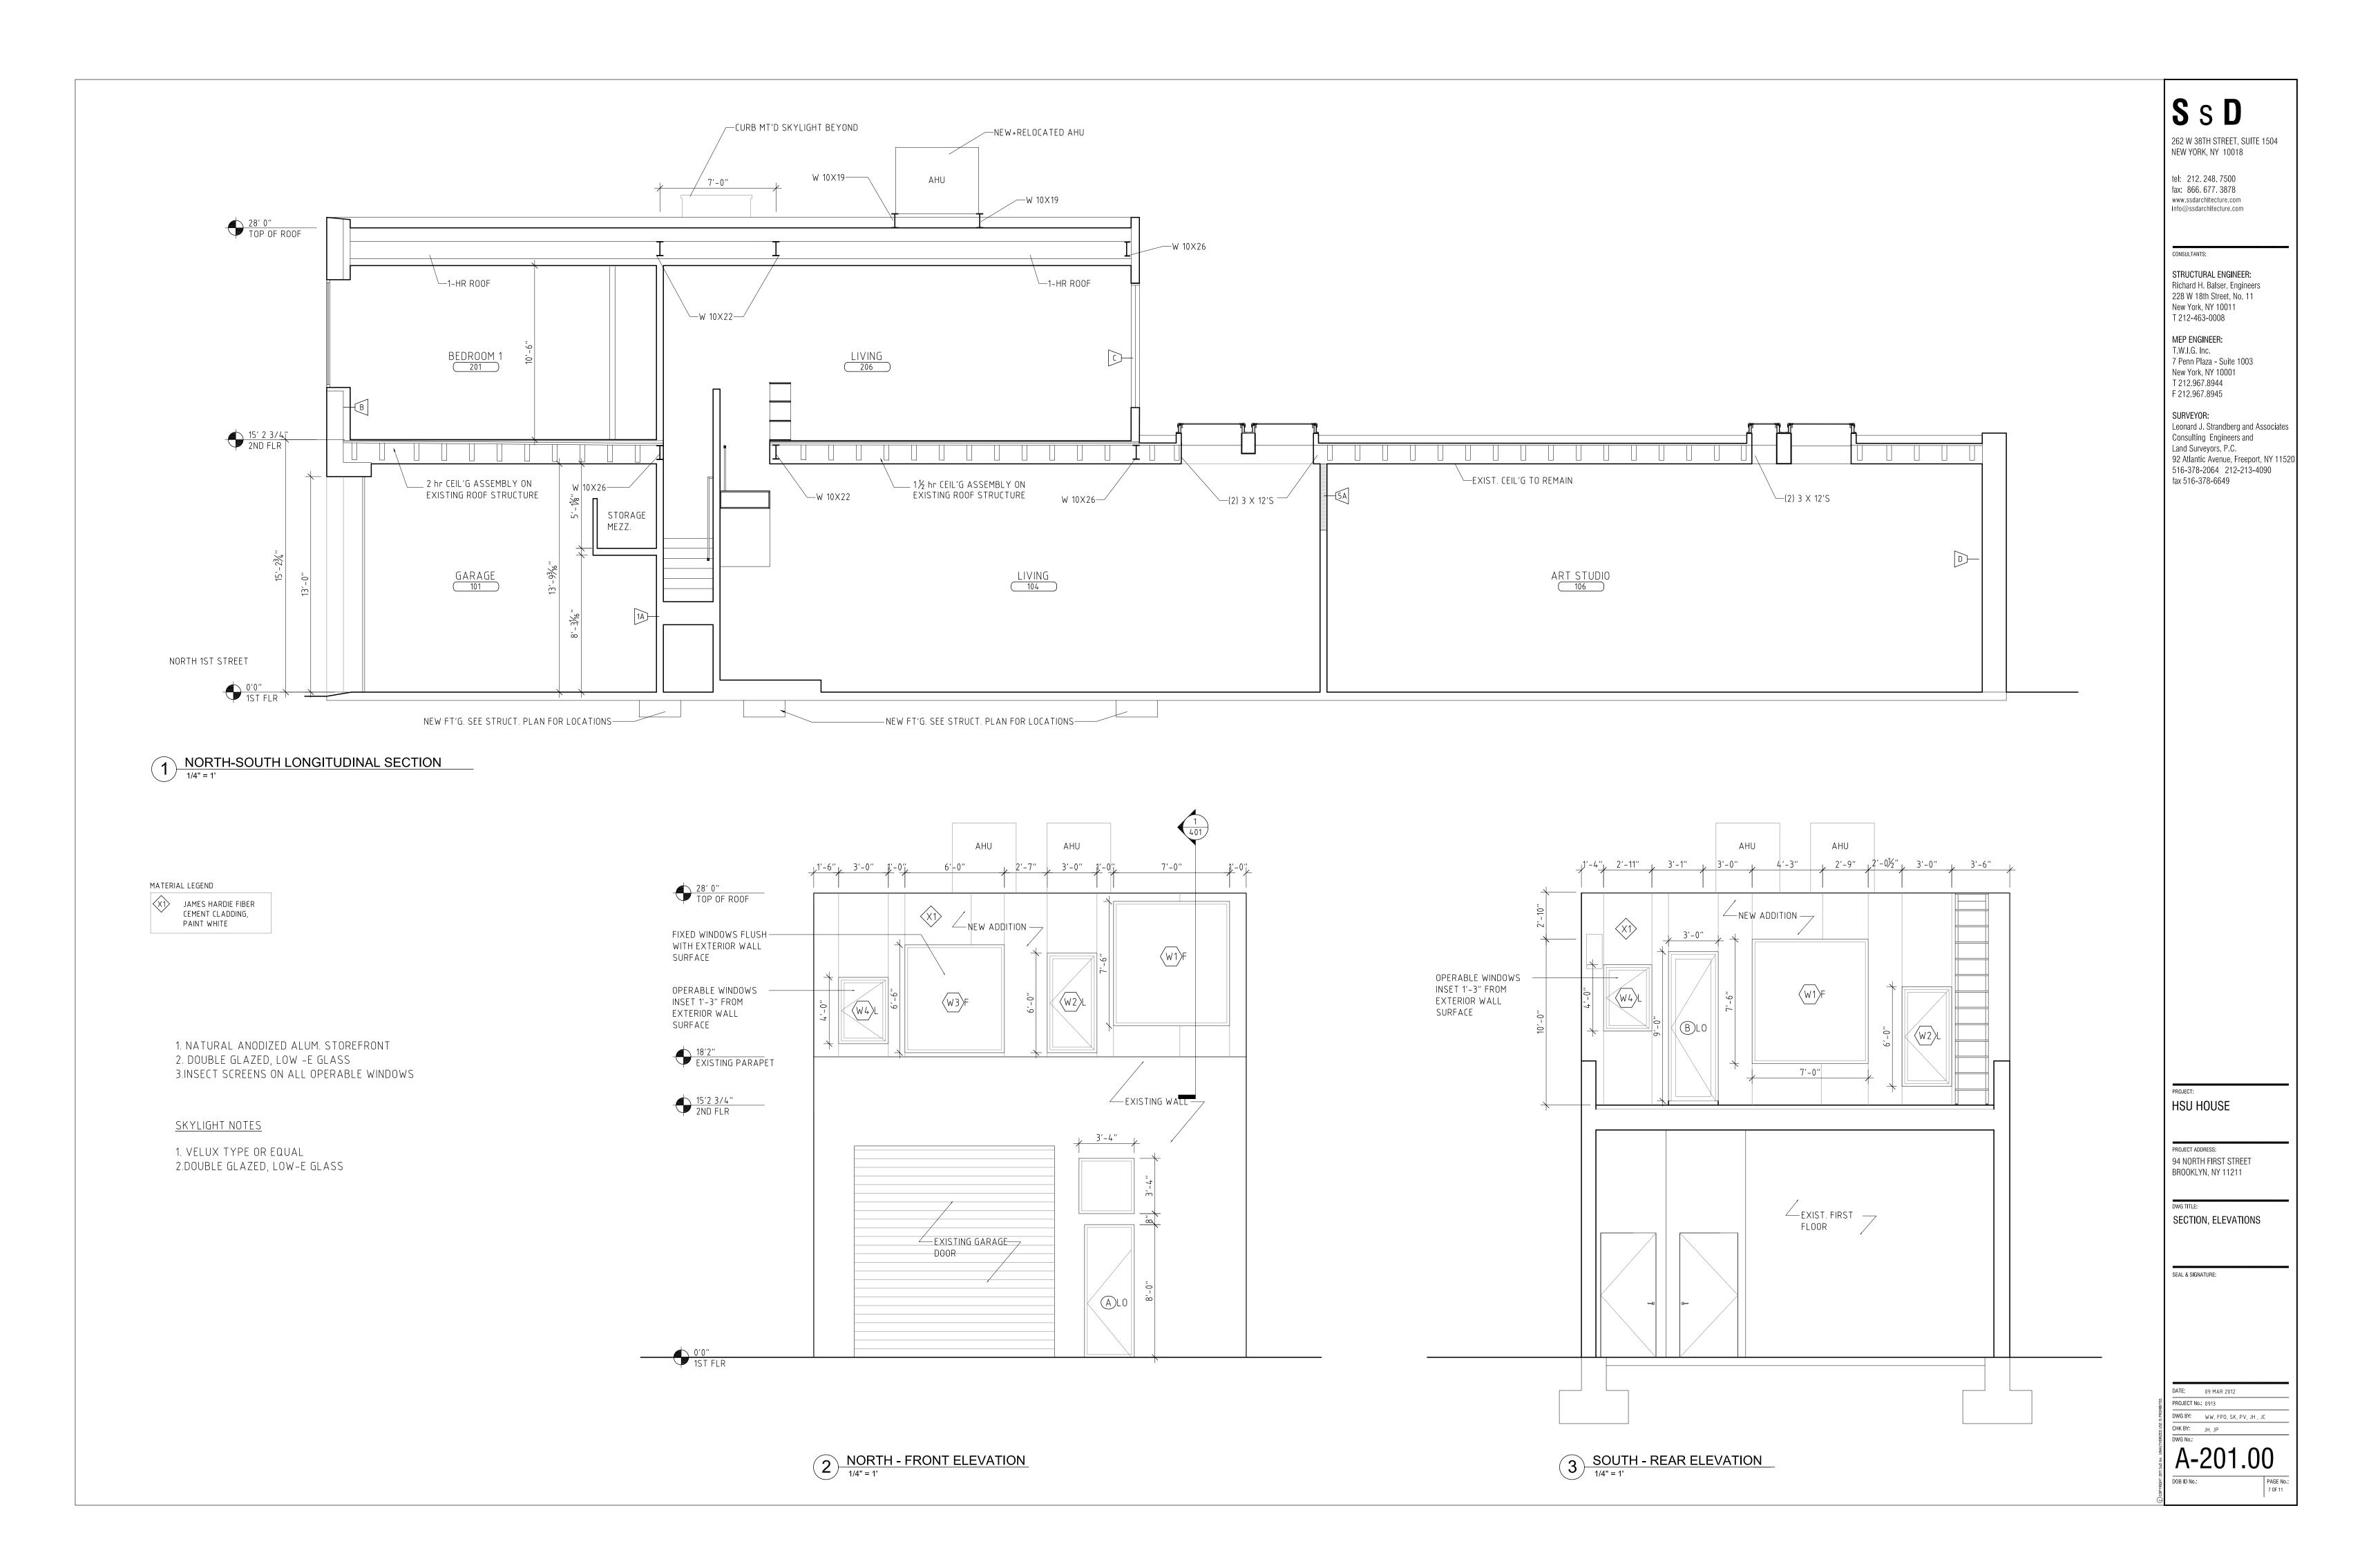

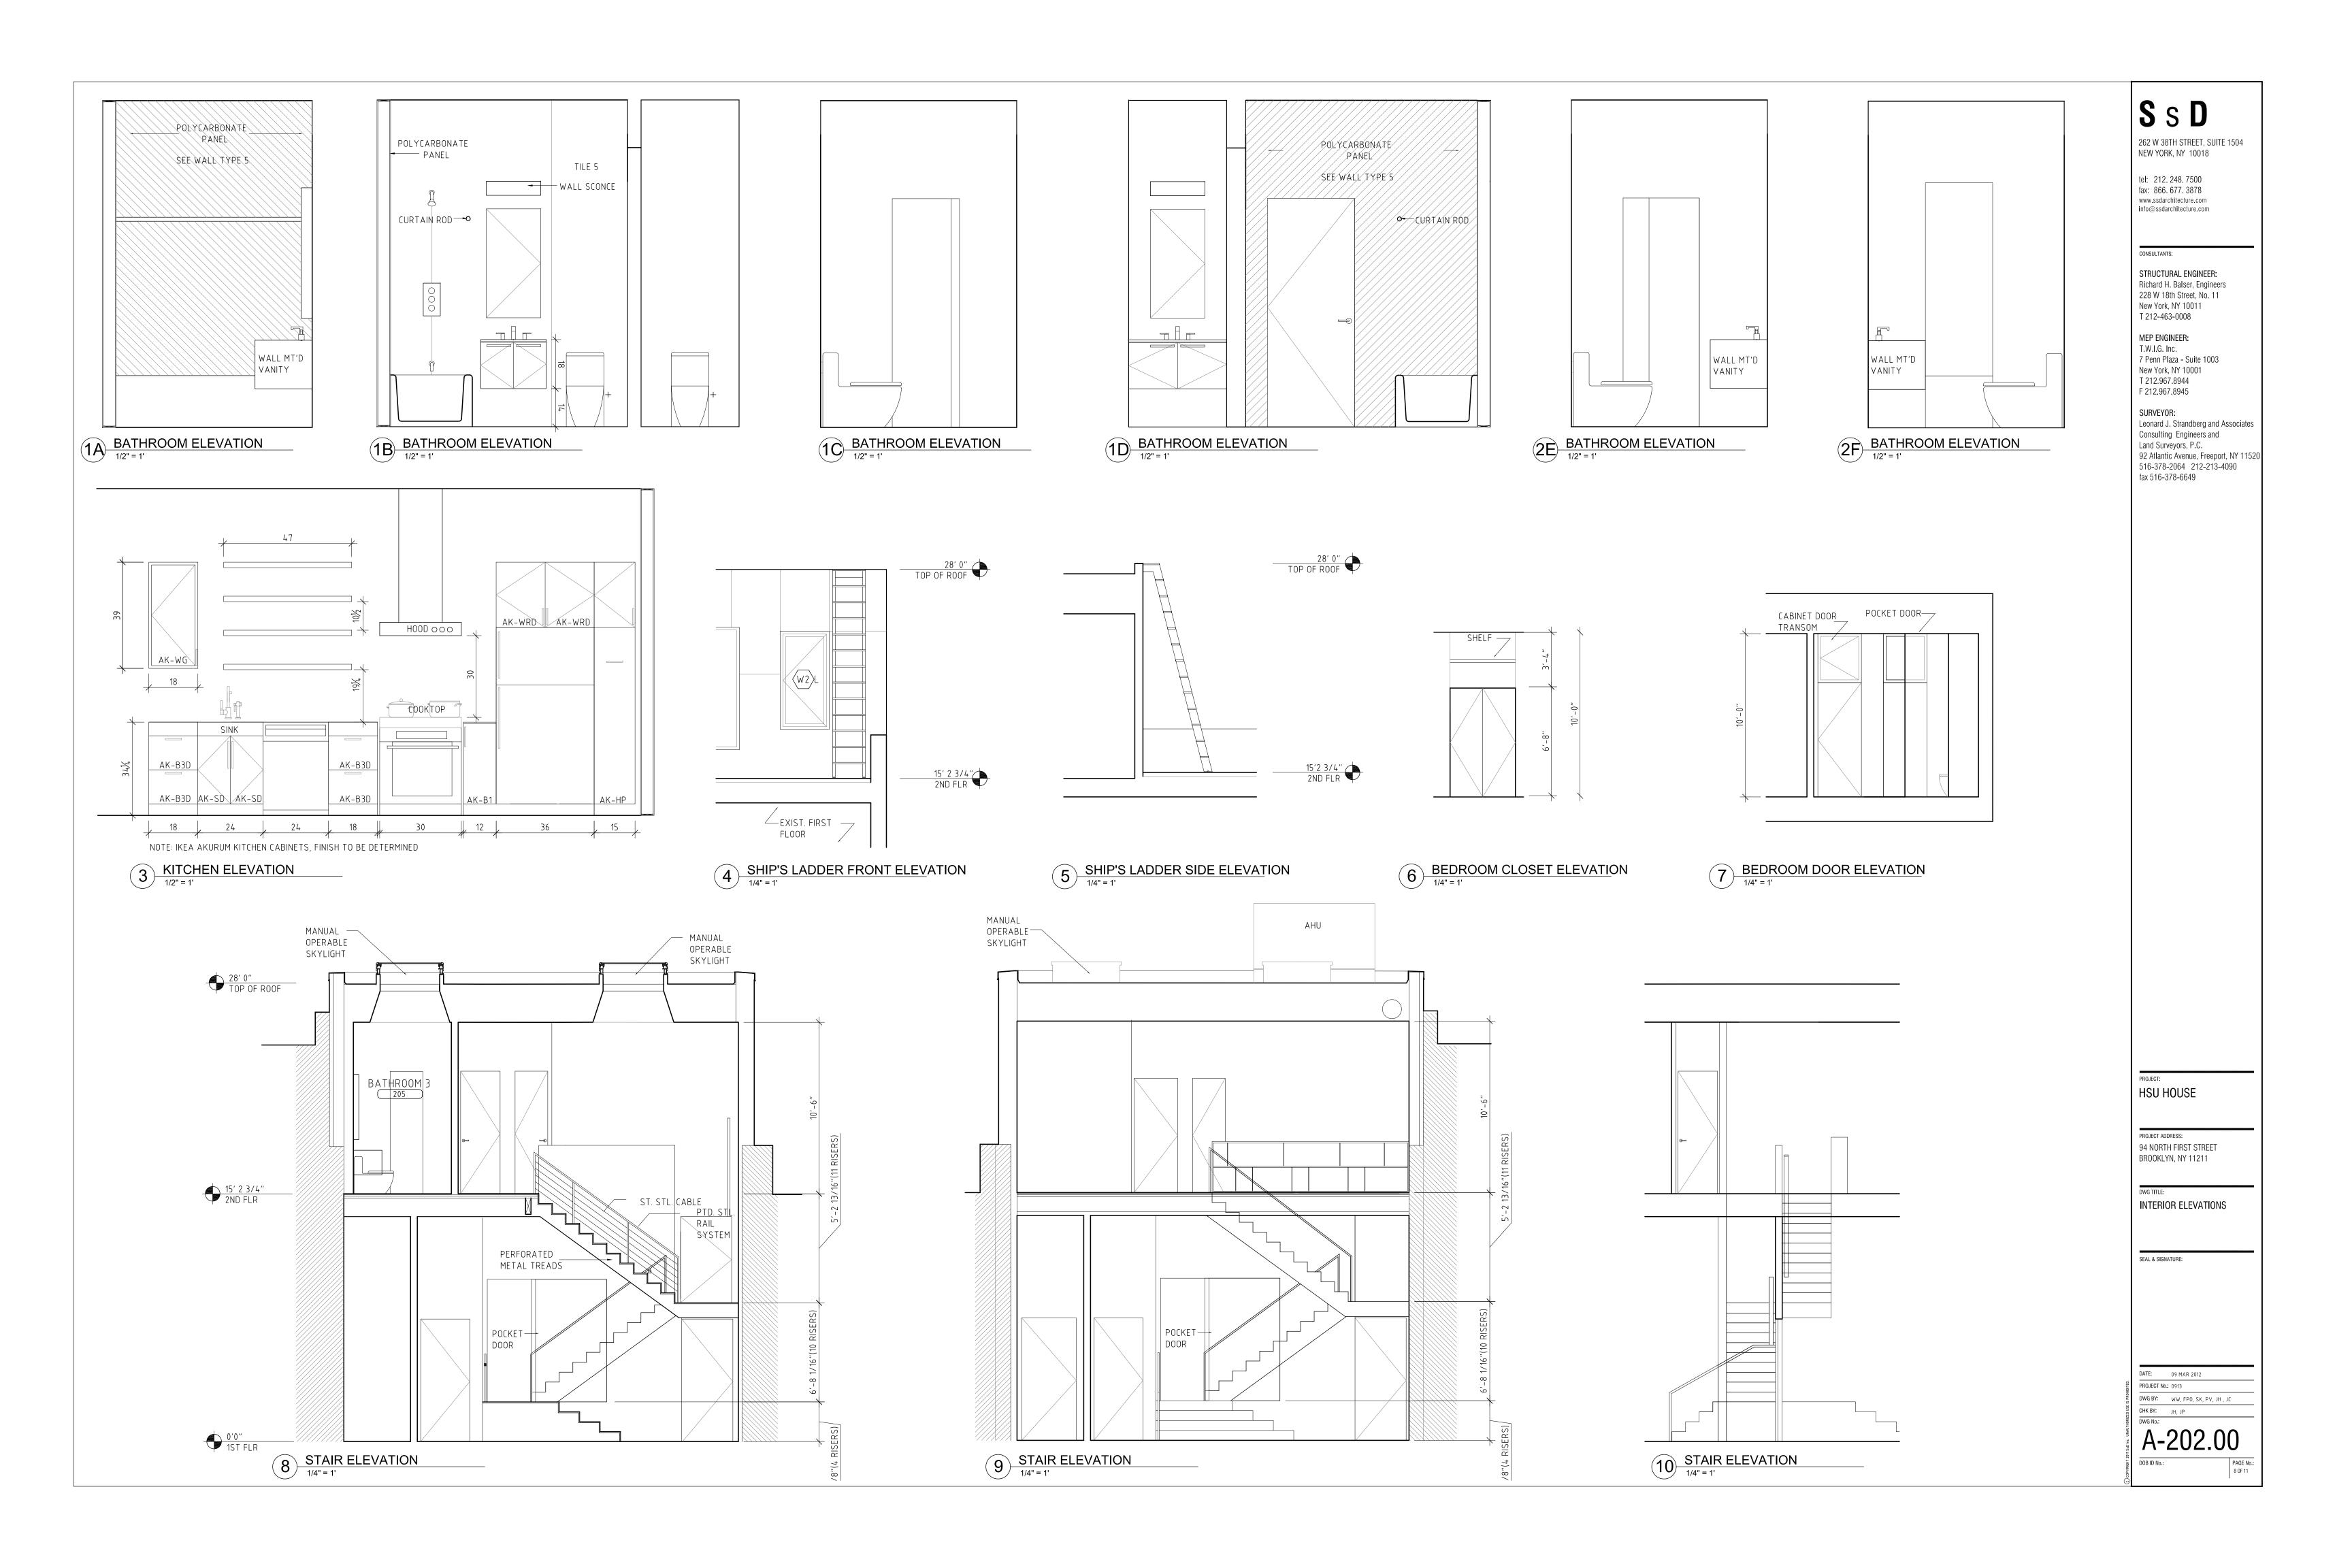

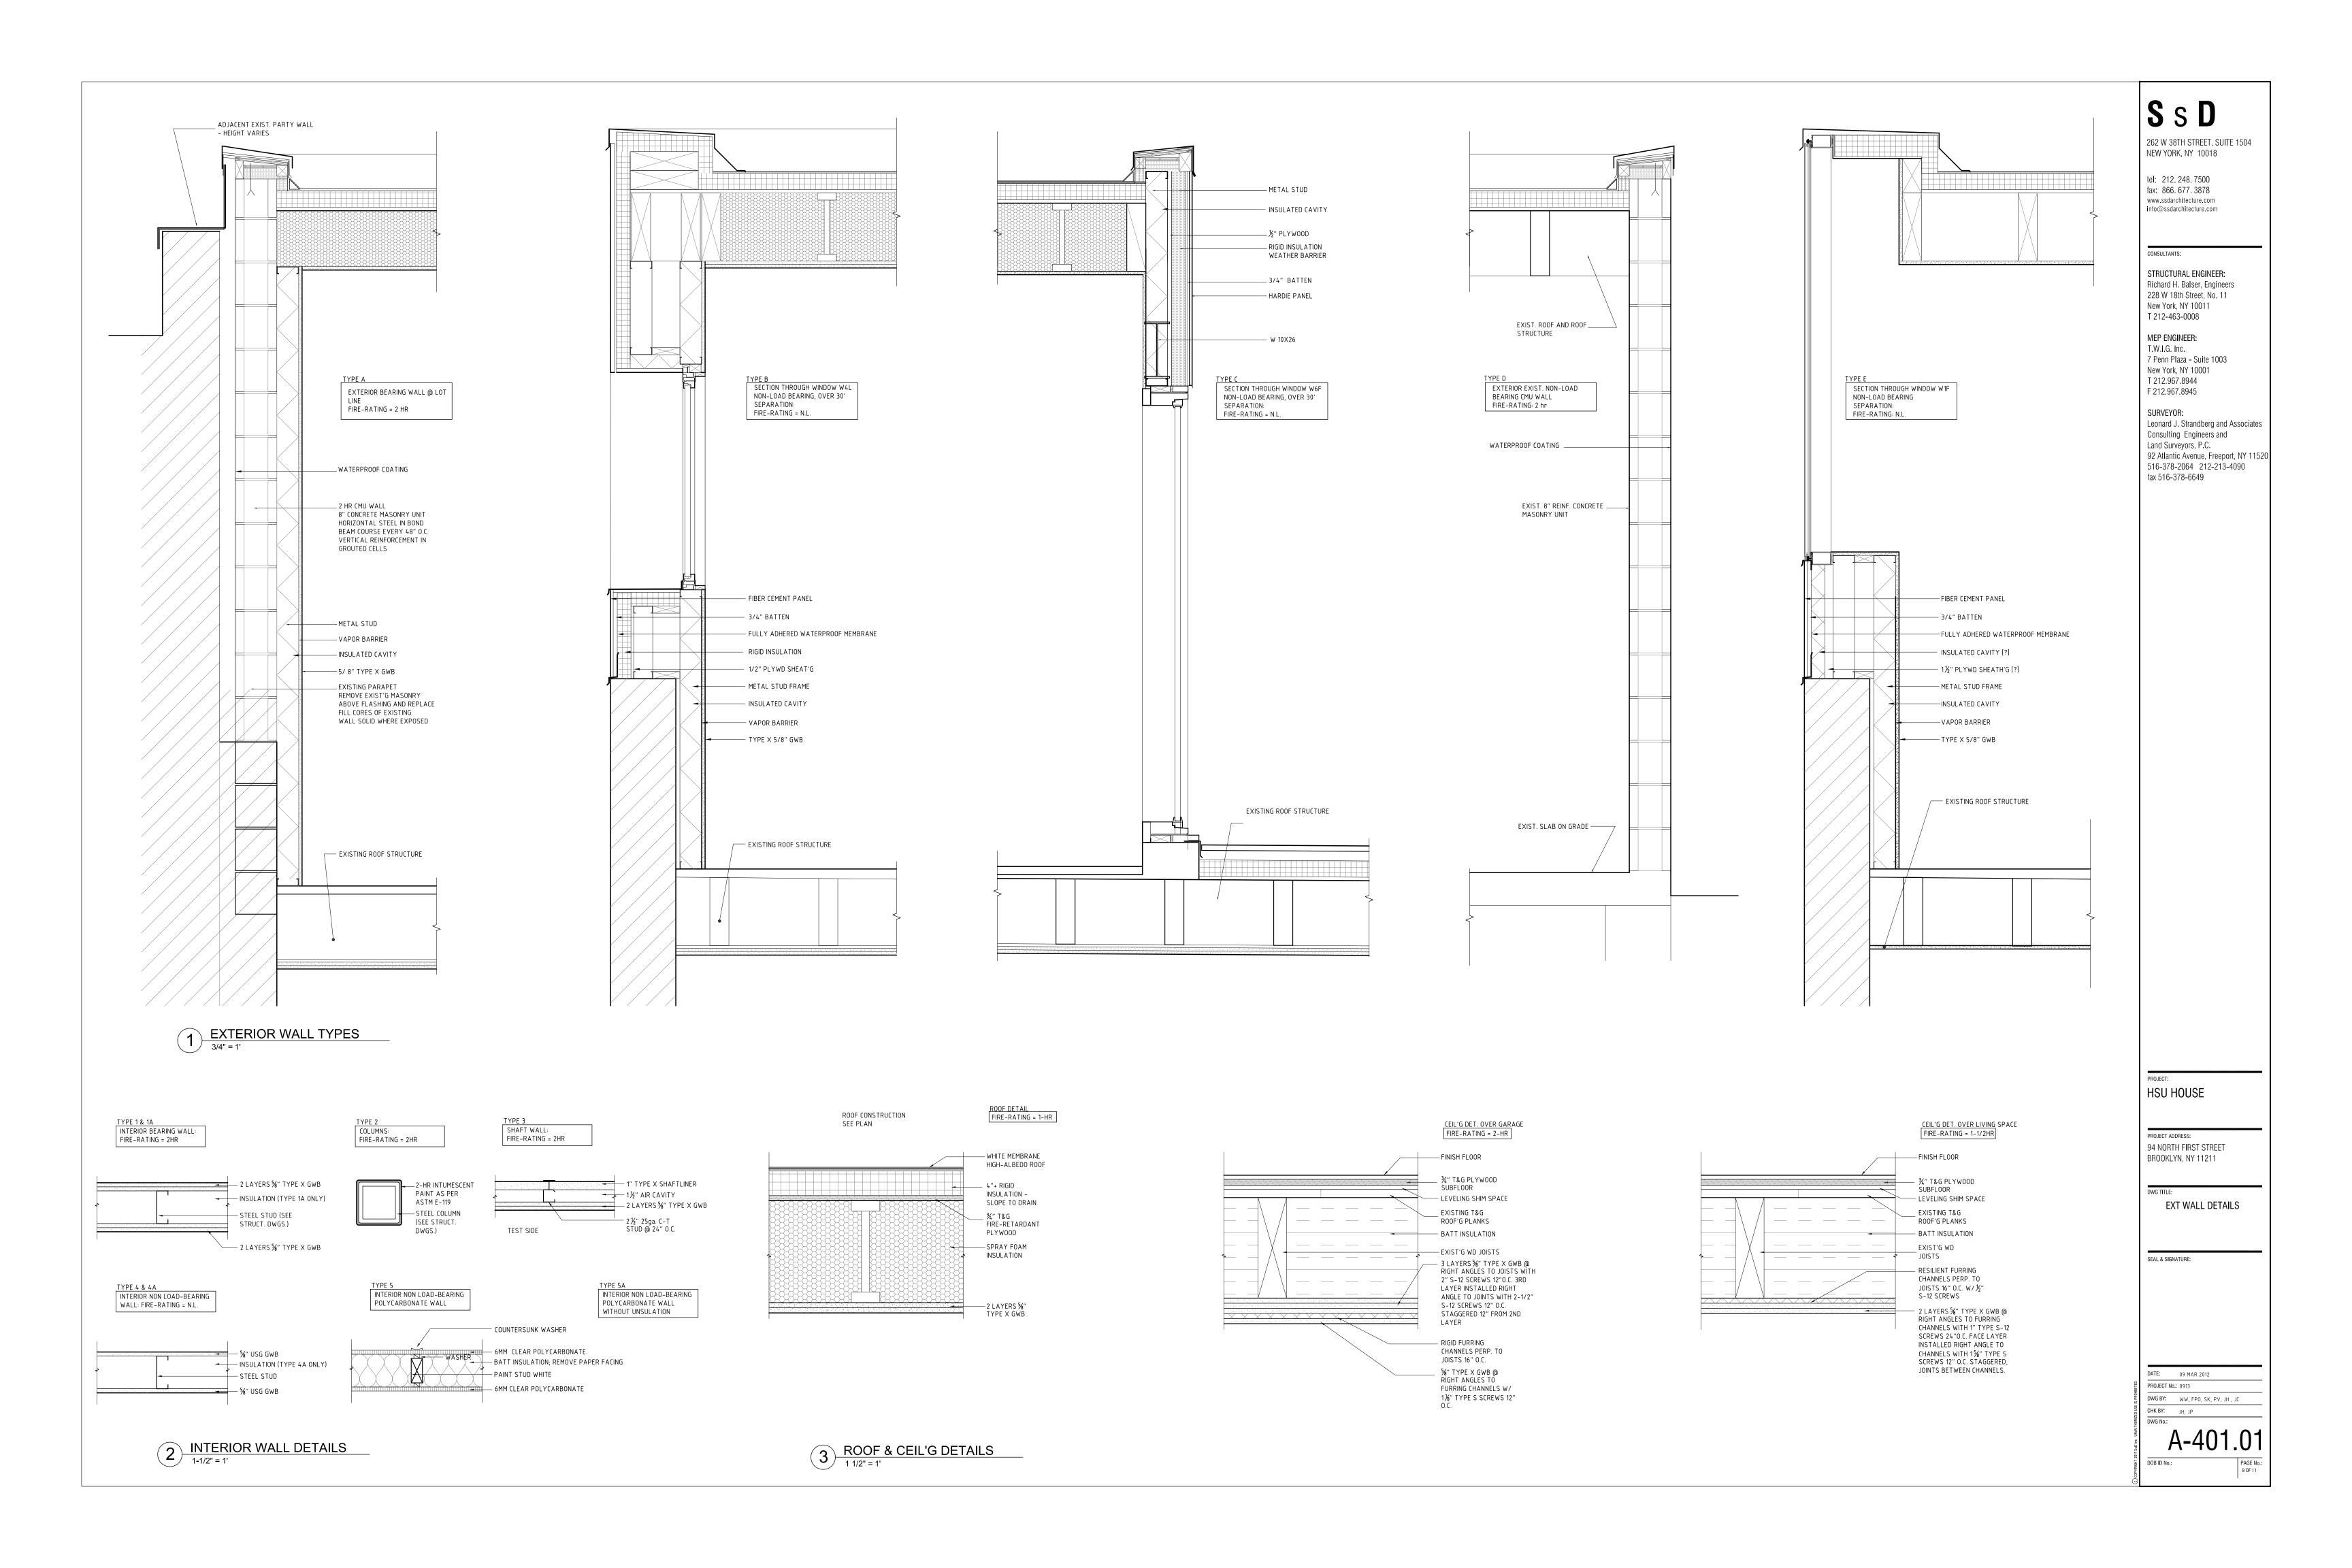

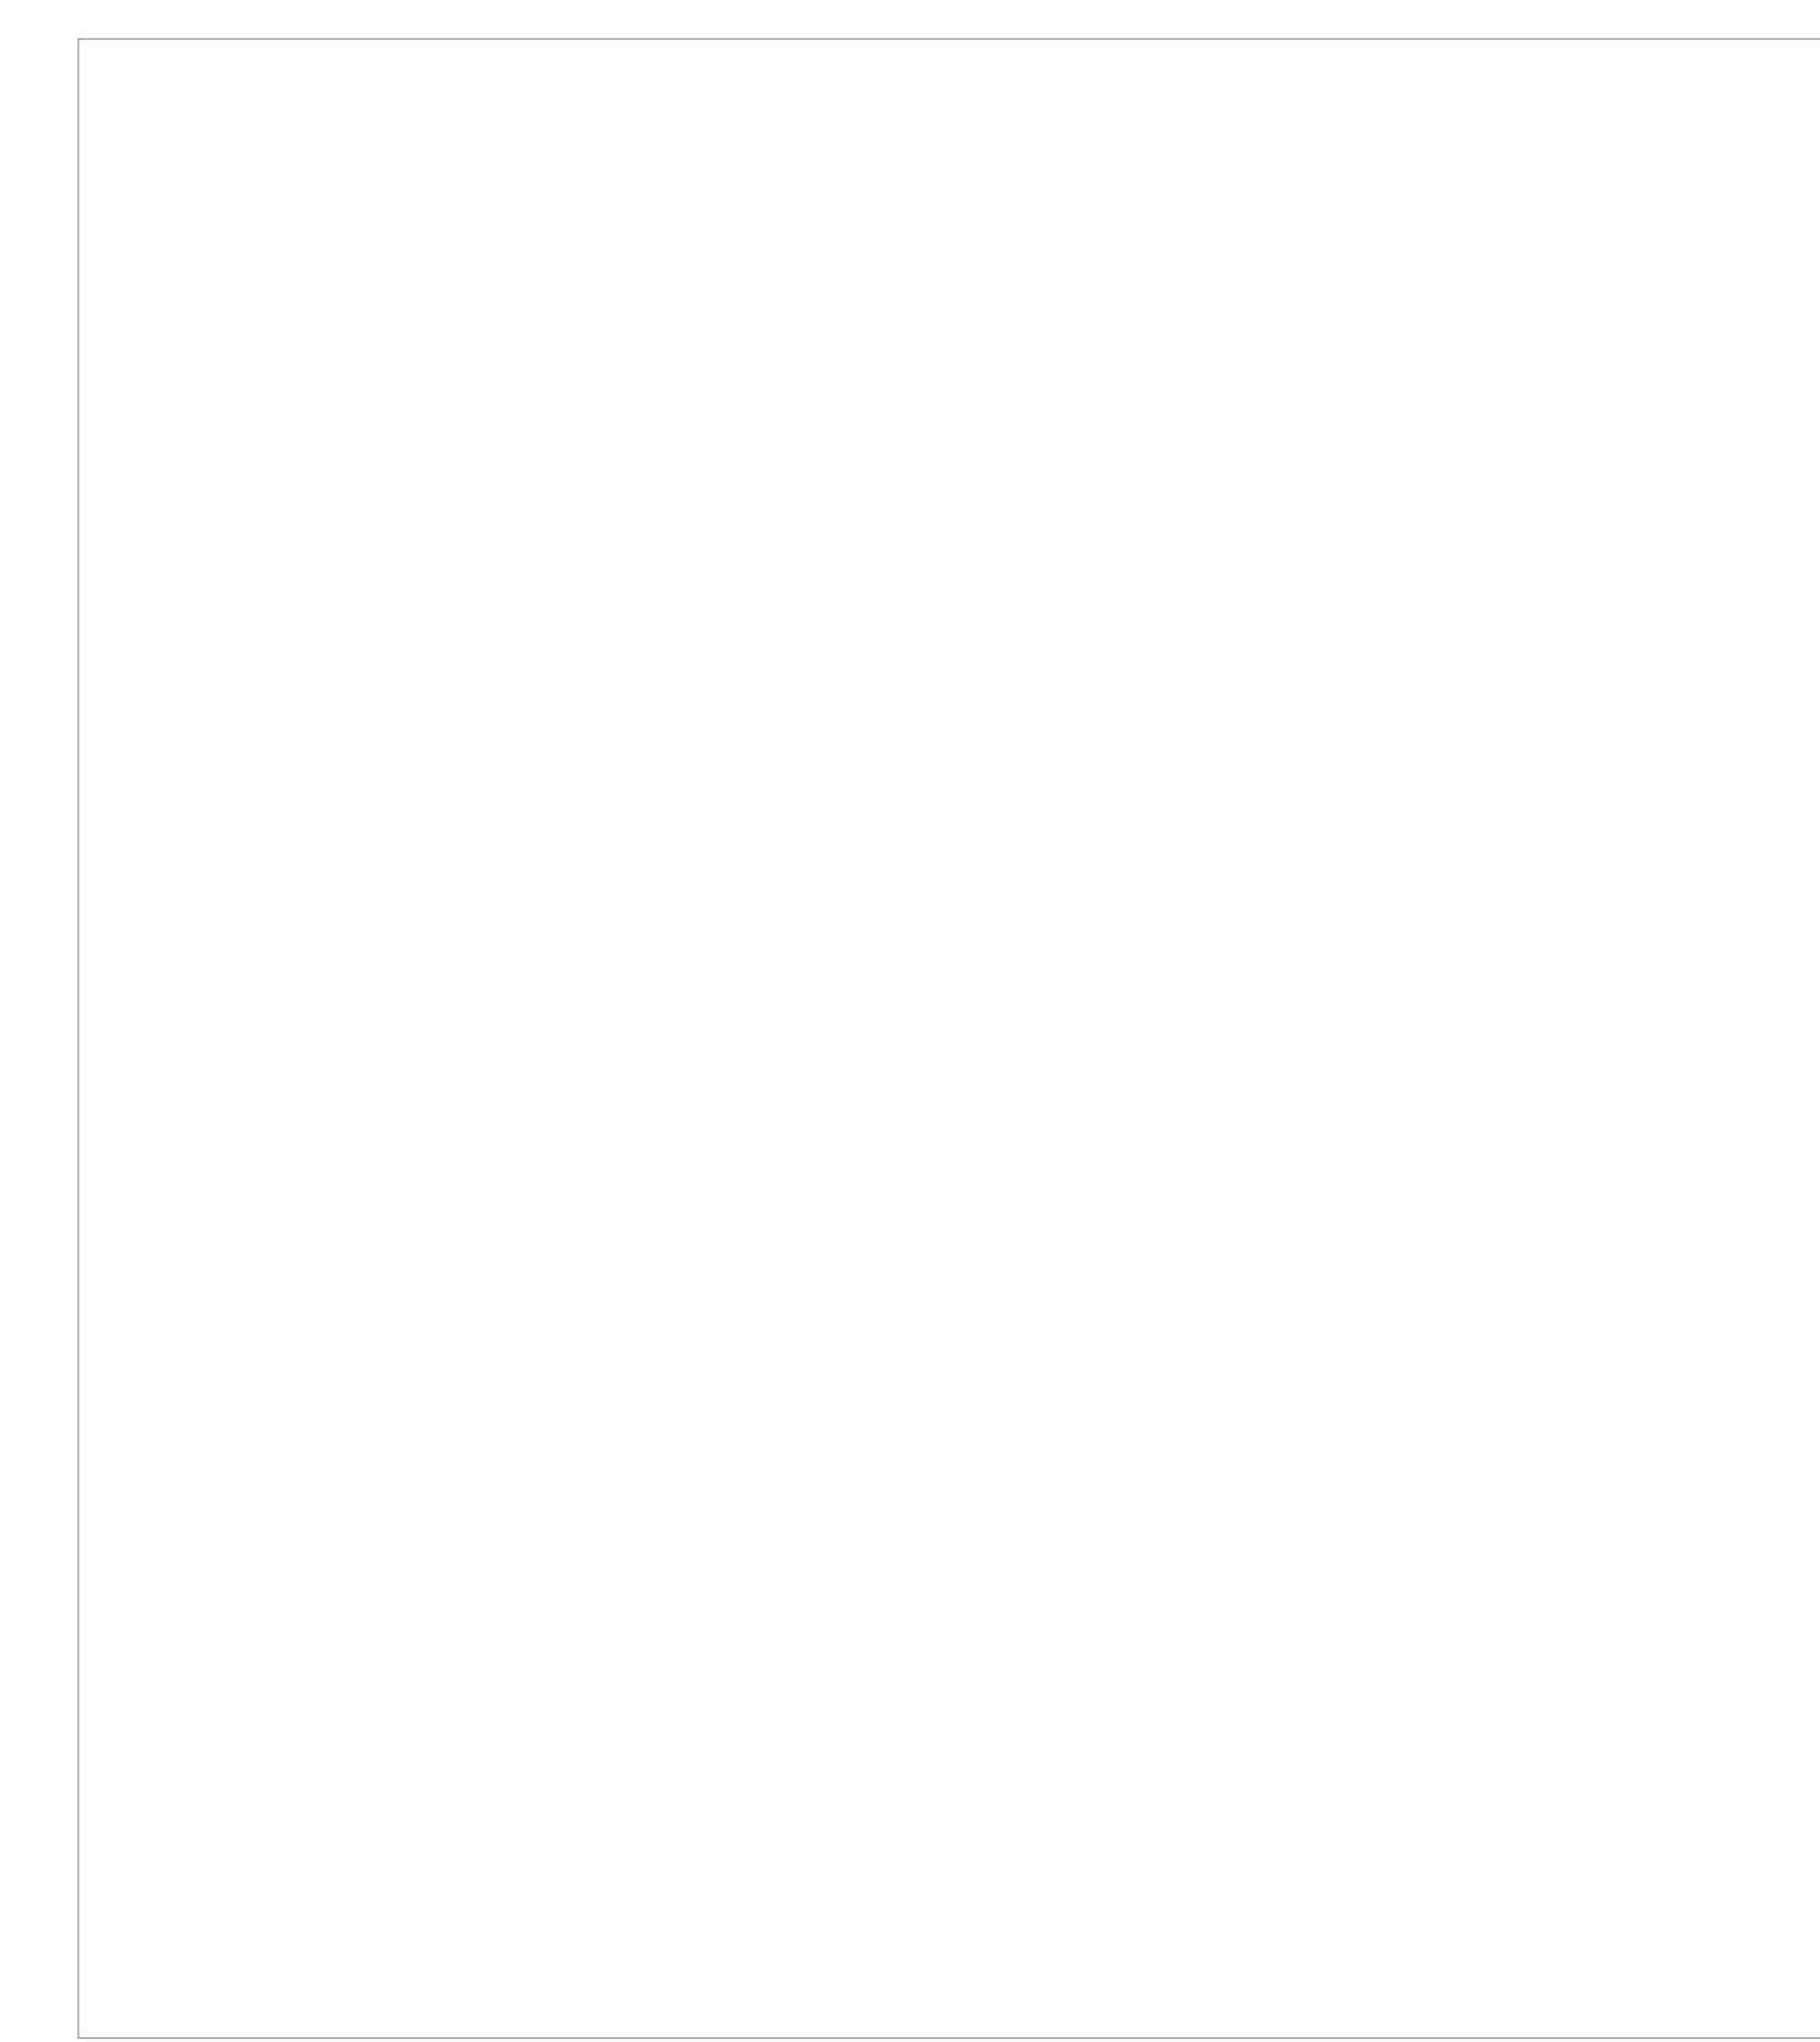



Project Title: Hsu Loft

Energy Code:

Location:
Construction Code
Kings County, New York
Construction Type:
Glazing Area Percentage:
Heating Degree Days:
Climate Zone:

2010 New York Energy Conservation
Construction Code
Kings County, New York
Detached 1 or 2 Family
16%
4910

Construction Site: 94 N. 1st Street Brookyn, NY 11211

Owner/Agent: Tishan Hsu Designer/Contractor:
John Hong
SsD Architecture
325 W 38th St.
Suite 210
New York, NY 10018
212 248 7500
info@ssdarchitecture.com

Compliance: Passes using UA trade-off

Compliance: 16.7% Better Than Code Maximum UA: 472 Your UA: 393

The % Better or Worse Than Code index reflects how close to compliance the house is based on code trade-off rules.

It DOES NOT provide an estimate of energy use or cost relative to a minimum-code home.

Assembly	Gross Area or Perimeter	Cavity R-Value	Cont. R-Value	Glazing or Door U-Factor	UA
Ceiling 1: Flat Ceiling or Scissor Truss	965	38.0	12.0		17
Skylight 1: Metal Frame with Thermal Break:Double Pane	180			0.500	90
Wall 1: Steel Frame, 16" o.c.	663	10.0	15.0		20
Window 1: Metal Frame with Thermal Break:Double Pane	220			0.460	101
Door 1: Glass	80			0.460	37
Wall 2: Masonry Block with Empty Cells:Interior Insulation	1240	0.0	9.0		102
Floor 1: All-Wood Joist/Truss:Over Unconditioned Space	1042	40.0	0.0		26

Compliance Statement: The proposed building design described here is consistent with the building plans, specifications, and other calculations submitted with the permit application. The proposed building has been designed to meet the 2010 New York Energy Conservation Construction Code requirements in REScheck Version 4.4.1 and to comply with the mandatory requirements listed in the REScheck Inspection Checklist.

Signature

Name - Title

Project Notes:
FOR 1 STORY ADDITION TO PRE-EXISTING BUILDING

Project Title: Hsu Loft

Data filename: C:\Users\johnhong\S-local\0913_HsuLoft\0913_zoning-code\RESCHECK\HSULOFT_RESCHECK00.rck

Report date: 03/27/11 (00.rck Page 1 of 1 **S** s **D**

262 W 38TH STREET, SUITE 1504 NEW YORK, NY 10018

tel: 212, 248, 7500 fax: 866, 677, 3878 www.ssdarchitecture.com info@ssdarchitecture.com

CONSULTANTS:

STRUCTURAL ENGINEER: Richard H. Balser, Engineers 228 W 18th Street, No. 11 New York, NY 10011 T 212-463-0008

MEP ENGINEER:

T.W.I.G. Inc. 7 Penn Plaza - Suite 1003 New York, NY 10001 T 212.967.8944 F 212.967.8945

SURVEYOR:

Leonard J. Strandberg and Associates Consulting Engineers and Land Surveyors, P.C. 92 Atlantic Avenue, Freeport, NY 11520 516-378-2064 212-213-4090 fax 516-378-6649

HSU HOUSE

PROJECT ADDRESS: 94 NORTH FIRST STREET BROOKLYN, NY 11211

ENERGY COMPLIANCE REPORT

SEAL & SIGNATURE:


DATE: 31 MAY 2011


PROJECT No.: 0913

DWG BY: WW, FPO, SK, PV, JH

CHK BY: JH, JP

EN-001.0

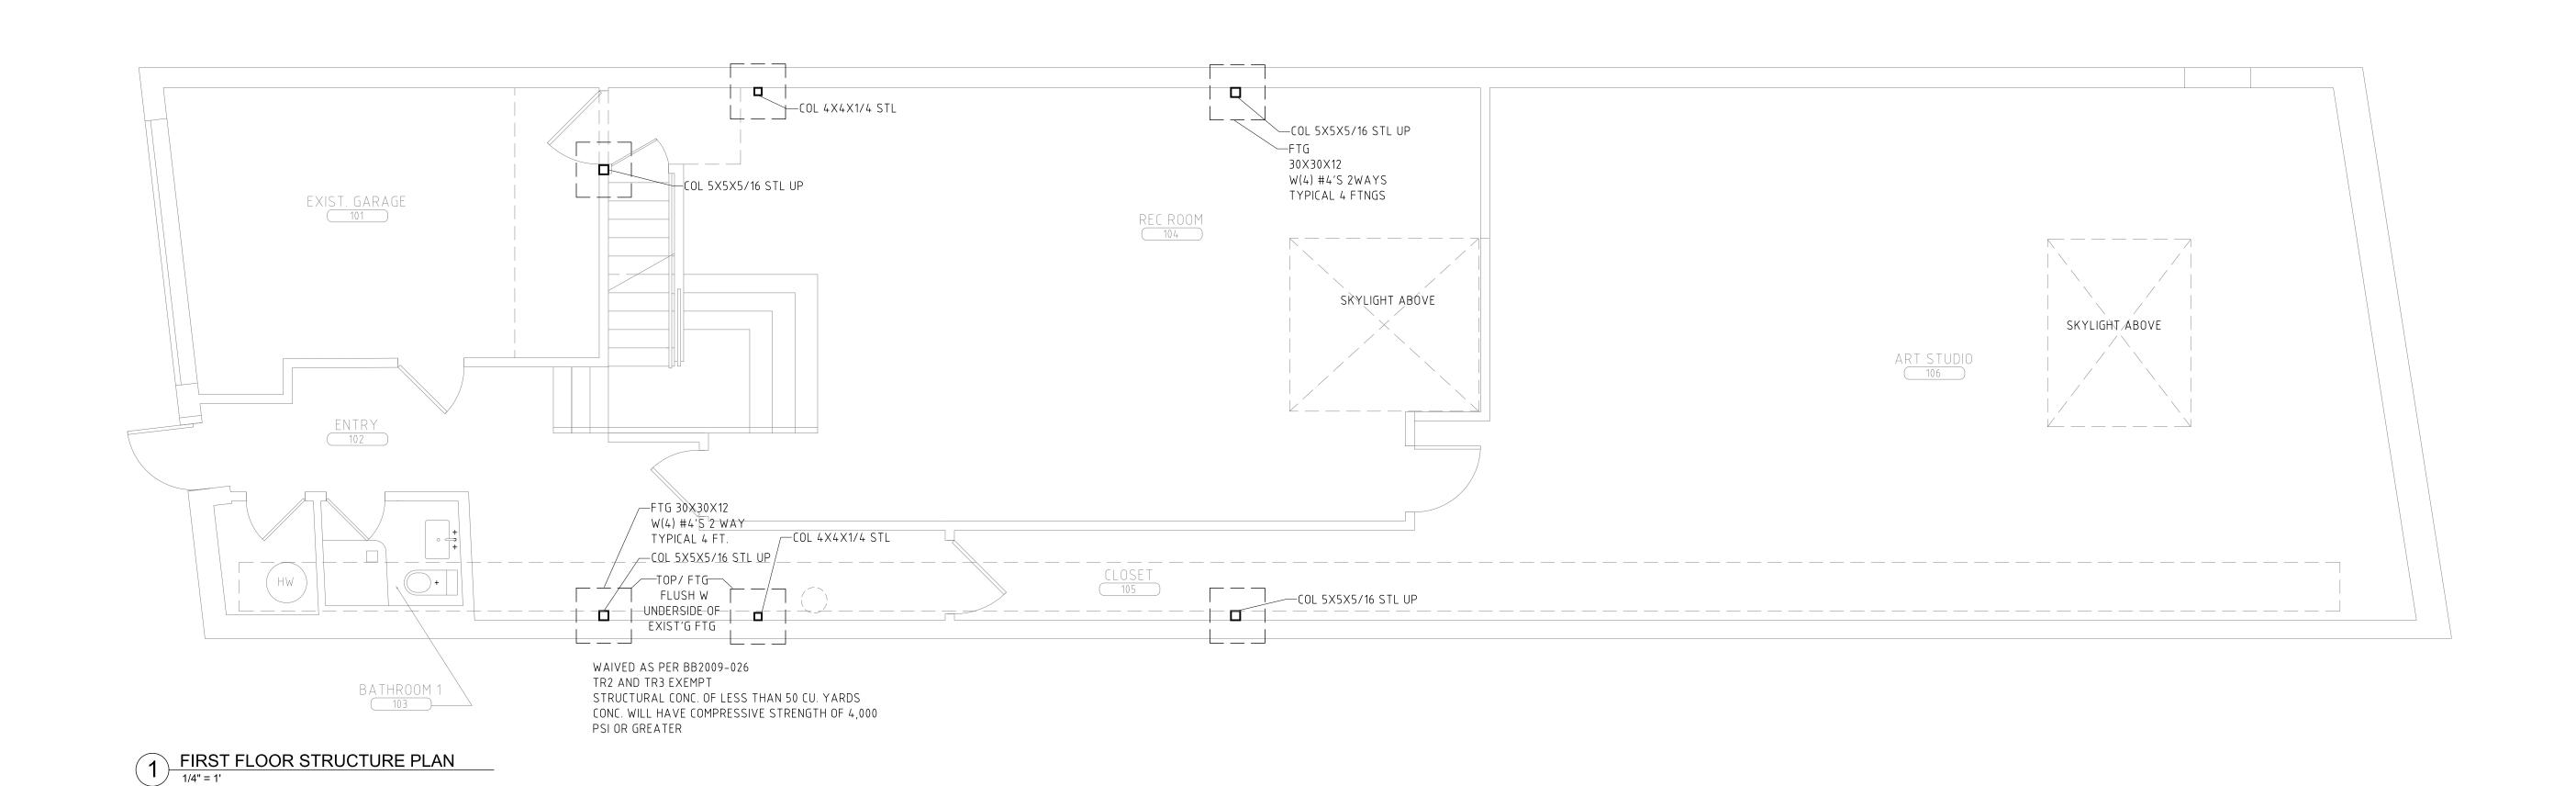

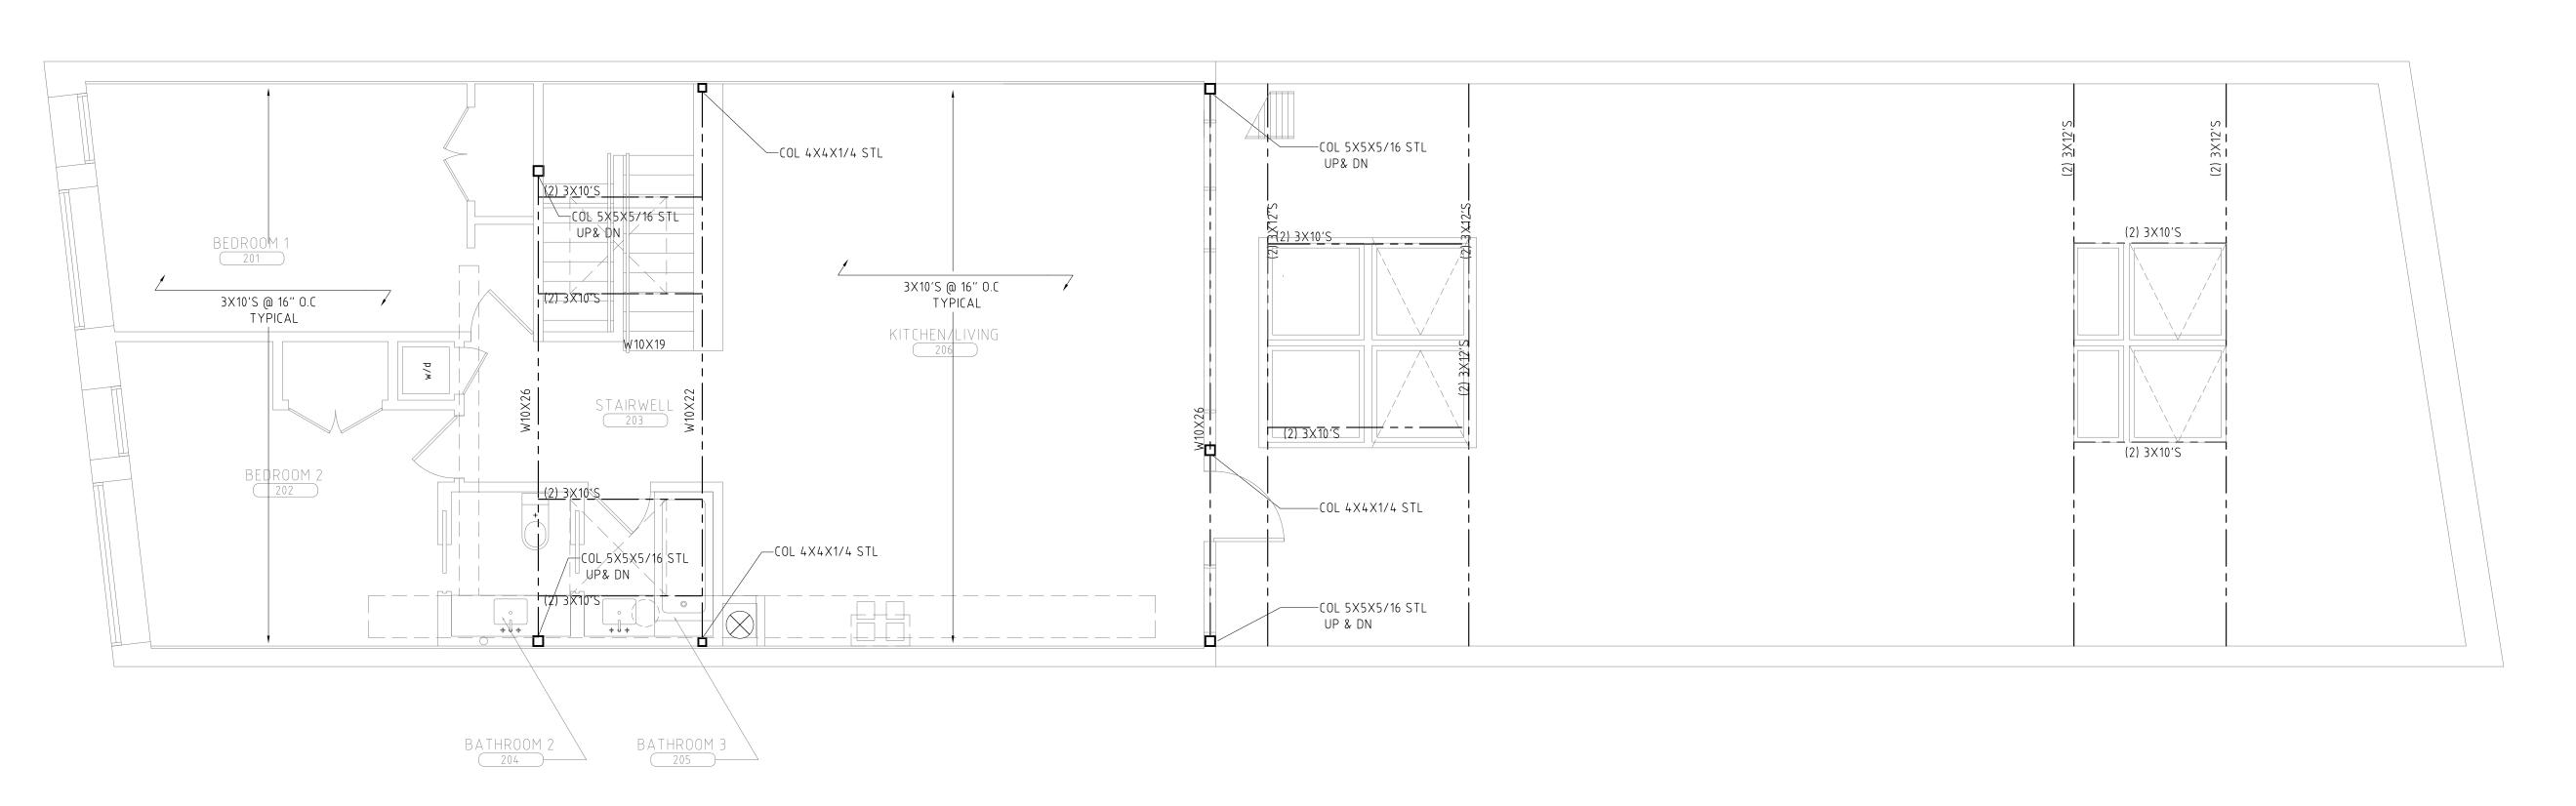

2ND FLOOR STRUCTURE PLAN
1/4" = 1'

S S **D**

262 W 38TH STREET, SUITE 1504 NEW YORK, NY 10018

tel: 212. 248. 7500 fax: 866. 677. 3878 www.ssdarchitecture.com info@ssdarchitecture.com

CONSULTANTS:

STRUCTURAL ENGINEER: Richard H. Balser, Engineers 228 W 18th Street, No. 11 New York, NY 10011 T 212-463-0008

MEP ENGINEER: T.W.I.G. Inc. 7 Penn Plaza - Suite 1003 New York, NY 10001

7 Penn Plaza - Suite New York, NY 10001 T 212.967.8944 F 212.967.8945

SURVEYOR:
Leonard J. Strandberg and Associates
Consulting Engineers and
Land Surveyors, P.C.
92 Atlantic Avenue, Freeport, NY 11520
516-378-2064 212-213-4090
fax 516-378-6649

HSU HOUSE

PROJECT ADDRESS: 94 NORTH FIRST STREET BROOKLYN, NY 11211

STRUCTURAL PLANS, 1ST FLR, 2ND FLR

SEAL & SIGNATURE:

DATE: 09 MAR 2012

PROJECT No.: 0913

DWG BY: WW, FPO, SK, PV, JH, JC

CHK BY: JH, JP

DWG No.:

S-101.0

10 O

