### GENERAL CONSTRUCTION NOTES

- 1. THE CONTRACTOR SHALL EXAMINE ALL AREAS IN WHICH HIS/HER WORK IS TO BE INSTALLED, AND SHALL REPORT ANY UNSUITABLE CONDITIONS. THE CONTRACTOR WILL BE HELD RESPONSIBLE FOR CONDITIONS OF THE FINISHED WORK AND NO CLAIM AS TO DEFECTS IN UNDERLYING WORK IS CONSIDERED AFTER WORK UNDER THIS CONTRACT IS STARTED.
- 2. THE CONTRACTOR, BEFORE STARTING ANY WORK, SHALL VERIFY ALL DIMENSIONS AND LEVELS GIVEN FOR WORK UNDER THIS CONTRACT, IN CONJUNCTION WITH ARCHITECT'S OF ENGINEER'S DRAWINGS AND DETAILS.
- 3. DEMOLITION SHALL BE CARRIED OUT ACCORDING TO THE RULES OF THE DEPARTMENT OF BUILDINGS AND NOT WITHOUT TIMELY NOTIFICATION TO THE BUILDING DEPARTMENT.
- 4. BUILDING TO CONFORM WITH APPLICABLE PROVISIONS OF THE MULTIPLE DWELLING HOUSING MAINTENANCE CODE & BUILDING DEPARTMENT'S RULES AND REGULATIONS.
- 5. ALL WORK SHALL BE IN ACCORDANCE WITH ALL APPLICABLE RULES OF THE BUILDING CODE AND ANY OTHER AUTHORITY HAVING JURISDICTION. NO WORK SHALL BEGIN AT THE SITE UNTIL BUILDING DEPARTMENT APPROVAL AND REQUIRED PERMITS HAVE BEEN OBTAINED.
- 6. CONTROLLED INSPECTIONS:

  -FIRE STOPPING

  -MECH./ VENTILATION

  -STRUCTURAL/STABILITY

  -STEEL: BOLTED CONNECTIONS AND WELDING

  -CONCRETE/FOOTINGS

  -REINFORCING

### TENANT SAFETY NOTES

- 1. CONSTRUCTION WILL BE CONFINED TO AREA INDICATED, AND WILL NOT CREATE DUST, DIRT OR OTHER SUCH INCONVENIENCES TO APARTMENT UNITS WITHIN THE BUILDING.
- 2. CONSTRUCTION OPERATION WILL NOT BLOCK HALLWAYS OR MEANS OF EGRESS FOR TENANTS OF THE BUILDING.
- 3. CONSTRUCTION OPERATION WILL NOT INVOLVE INTERUPTION OF HEATING, GAS, WATER OR ELECTRICAL SERVICES TO OTHER OCCUPANTS OF THE BUILDING.
- 4. CONSTRUCTION OPERATIONS WILL BE CONFINED TO NORMAL WORKING HOURS DETERMINED BY THE BUILDING'S REGULATIONS.
- 5. THE STRUCTURAL INTEGRITY OF THE BUILDING IS TO BE PROTECTED AT ALL,
- 6. BUILDING SECURITY TO BE MAINTAINED TO PREVENT UNAUTHORIZED PERSONS FROM ENTERING BUILDING.

156.7

ZONING: MX-8, MI-2/R6A, e2 AND R6A W/ C2-4 OVERLAY

DESCRIPTION: ADDITION TO EXISTING BUILDING, CONVERSION TO SINGLE FAMILY RESIDENTIAL.

ADDRESS: 94 N. 1 ST BROOKLYN, NY

COMMUNITY DISTRICT: BROOKLYN COMMUNITY DISTRICT 1

94 N. 1st STREET

ADJ EXIST

2 STORY

BLDG

SEE SITEPLAN

INFQ

A-001 FOR ADD'L.

MX-8 IN MI-2/R6A/e2

R6-A W C2-4 OVERLAY in

EXIST. STREET LAMP - X - EXIST. CURB CUT

2ND

EXIST

STORY

STORY

ADDITION

STEEL

STUD/

MASONRY

1 STORY

EXISTING BRICK

24.9'

PLOT PLAN

SEE SURVEY AND

SITEPLAN FOR ADD'L INFO

1:400

7. ALL EXISTING EXITS, FIRE PROTECTION DEVICES AND ALARMS SHALL BE CONTINUOUSLY MAINTAINED IN WORKING ORDER.

**ZONING MAP:12C** 

**BLOCK NO: 2379** 

LOT NO: 12

### HOUSING MAINTENANCE NOTES

- 1. PAINTING OF PUBLIC PARTS & WITHIN DWELLING TO COMPLY WITH SECTION D26-12.01 H.M.C. & SECTION 80 M.D.L.
- 2. PAINTING OF WINDOW FRAMES & FIRE ESCAPES TO COMPLY WITH SECTION D26-12.03 H.M.C.
- 3. WALLS OF COURTS & SHAFTS TO BE OF LIGHT COLORED SURFACE AS PER SECTION D26–12.05 H.M.C. & SECTION 29 M.D.L.
- 4. PREMISES TO BE MAINTAINED & KEPT FREE OF RODENT & INSECT INFESTATION AS PER SECTION D26-13.03 & D26-13.05 H.M.C.
- 5. RECEPTACLES FOR THE COLLECTION OF WASTE MATTER TO BE PROVIDED AS PER SECTION D.26-14.03 & D26-14.05 H.M.C. & SECTION 81 M.D.L.
- 6. DRAINAGE OF ROOFS, COURTS, & YARDS TO COMPLY WITH SECTION D26-16.03 H.M.C. & SECTION 77 SUBD. 3 M.D.L.
- 7. YEARLY INSPECTION OF CENTRAL HEATING PLANT BY QUALIFIED PERSON TO BE MADE AS PER SECTION D26-17.05 H.M.C. CENTRAL HEAT & HOT WATER TO BE PROVIDED AS PER SECTION 79 SUBD. 1 M.D.L.
- 8. PROPER ELECTRIC LIGHTING EQUIPMENT WITHIN DWELLING TO BE PROVIDED & MAINTAINED AS PER SECTION D26-19.01, D26-19.03 & D26-19.05 H.M.C.
- 9. PROPER ELECTRIC LIGHTS TO BE PROVIDED NEAR ENTRANCE WAYS, YARDS, & COURTS AS PER SECTION D26-19.07 H.M.C. ON SEPARATE CIRCUITS OR CONNECTED TO HOUSE LINE SERVICING PUBLIC HALLS, & IN ACCORDANCE WITH REQUIREMENTS & APPROVAL OF THE DEPT. OF WATER SUPPLY, GAS & ELECTRICITY AS PER SECTION 35 & 20, SUBD. 7A M.D.L. & DEPT. RULES & REGULATIONS.
- 10. B.S.A. APPROVED PEEPHOLES APPROXIMATELY 5 FEET ABOVE FINISHED FLOOR TO BE PROVIDED IN ENTRANCE DOORS OF DWELLING UNITS AS PER SECTION D26-20.01 H.M.C. & DEPT. RULES & REGULATIONS.
- 11. PROPERLY MOUNTED & SECURED POLISHED METAL VIEWING MIRRORS TO BE PROVIDED WITH SELF SERVICE ELEVATORS (IF ANY) AS PER SECTION D26-20.03 H.M.C. & DEPT. RULES & REGULATIONS.
- 12. KEY LOCKS IN THE ENTRANCE DOORS OF EACH DWELLING UNIT WITH AT LEAST ONE KEY TO BE PROVIDED BY OWNER AS PER SECTION D26-20.05 H.M.C. HEAVY DUTY LATCH SET DEAD BOLT THUMB TURN INSIDE.
- 13. APPROVED TYPE MAIL RECEPTACLES & DIRECTORY OF PERSONS LIVING IN THE DWELLING TO BE PROVIDED BY OWNER AS PER SECTION D26–12.01 H.M.C. & REGULATIONS OF THE POST OFFICE DEPT. & SECTION 57 M.D.L.
- 14. PROPER FLOOR SIGNS TO BE PROVIDED IN PUBLIC HALL NEAR STAIRS & ELEVATOR WITHIN STAIR ENCLOSURE AS PER SECTION D26-21.03 H.M.C. & DEPT. RULES & REGULATIONS.
- 15. PROPER STREET NUMBER TO BE PROVIDED IN FRONT ON DWELLING AS PER SECTION 82(3)-1.0 ADMIN. CODE, SEC. D26-21.05 H.M.C. & RULES &
- REGULATIONS OF BOROUGH PRESIDENT.

  16. PROPER JANITORIAL SERVICES TO BE PROVIDED AS PER SECTION D26–22.03
- 17. EVERY KITCHEN & KITCHENETTE TO BE PROVIDED WITH SINK HAVING MINIMUM 2" WASTE & TRAP PER SECTION D26-32.01 H.M.C.
- 18. ALL COMBUSTIBLE MATERIAL WITHIN ONE FOOT OF COOKING APPARATUS TO BE PROPERLY FIRE RETARDED & MINIMUM 2 FOOT CLEARANCE MAINTAINED ABOVE EXPOSED COOKING SURFACE. COMBUSTIBILE MATERIAL BETWEEN 2' & 3' ABOVE EXPOSED SURFACE TO BE FIRE RETARDED. SECTION D26-32.05 H.M.C. & DEPT. RULES & REGULATIONS, SEC. 33, SUBD. 3 M.D.L.

GARAGE FOR 4 MOTOR VEHICLES

15-011 APPLICABILITY WITHIN

SPECIAL DISTRICTS

15-024NOTICE OF FILING

15-025 DOUBLE GLAZED WINDOWS

15-112 LIGHT AND AIR

15-12 OPEN SPACE EQUIVALENT

"E" ZONING DESIGNATION:

CODE

**EXISTING CERTIFICATE OF OCCUPANCY:** 

#173454 DATED DEC 8, 1960 FOR FACTORY AND

CONSTRUCTION CLASSIFICATION: CLASS 3

NON-FIRE PROOF CONSTRUCTION PER 1938

**ZONING NOTES** 

1ST FLOOR EXISTING STRUCTURE COMPLIES WITH ZR-15,

PER 123-67 RESIDENTIAL CONVERSION

**CONFORMS** 

WILL COMPLY

**CONFORMS** 

SEE CALCS IN PLAN

OPPN 1/03 AND LITTLE E

**DEP APPROVAL ONLY** 

REQUIRED IF THE

ENLARGEMENT

INVOLVES

EXCAVATION/FOUNDATI

ON WORK.

- 19. NO KITCHEN SHALL BE OCCUPIED FOR SLEEPING PURPOSES SEC. D26–23.05 H.M.C.
- 20. REGISTRATION STATEMENT TO BE FILED AS PER SECTION D26-41.01 & D26-41.03 H.M.C.
- 21. REGISTRATION IDENTIFICATION SIGN CONTAINING DWELLING SERIAL NUMBER TO BE POSTED AS PER SECTION D26-41.15 H.M.C.
- 22. INDENTIFICATION OF MANAGING AGENT OR OWNER TO BE INDICATED ON TENANTS RECEIPT AS PER SECTION D26-41.17 H.M.C.
- 23. ALL BATHSROOMS, TOILETS & BATHING COMPARTMENTS TO HAVE CERAMIC TILE FLOOR & 6" MINIMUM CERAMIC TILE BASE WALLS & CEILINGS PLASTER AS PER SECTION D26-31.03 H.M.C.
- 24. ALL DOORS LEADING TO PUBLIC HALLS SHALL BE SELF CLOSING, NO TRANSOMS OR PLAIN GLASS PANELS.
- 25. BUILDING TO COMPLY WITH SECTION 64 M.D.L. GAS METERS, GAS APPLIANCES & ARTIFICIAL LIGHTING.
- 26. BUILDING TO COMPLY WITH SECTION D26-33.03 H.M.C. MAXIMUM OCCUPANCY MIN. ROOM AREA, ART. 33, D26-33.01 SUBD. B & E.
- 27. ENTIRE BUILDING TO COMPLY WITH LOCAL LAWS APPLICABLE TO ART, 6 WITH H.M.C. & DEPT, RULES & REGULATIONS.
- 28. ALL NEWLY CREATED PARTITIONS IN HALLS TO BE FIRE RETARDED ON BOTH SIDES & FIRE STOPPED AT TOP & BOTTOM AS PER DEPT. RULES & REGULATIONS, RULE 1.2.10 & RULE 1.7.

ZONII	NG NOTES (CONT.)		
SINGLE STORY ADDITION ON SECO ZR-77 FOR MI	ND LEVEL COMPLIES WITH XED R6A AND MX-8 DISTRI		
TOTAL EXISTING LOT AREA	24.9 x ±101 =	2526 sf	
LOT AREA IN MX-8, MI-2/R6A	24.9 x ±90 =	2255 sf	
LOT AREA IN R6A/C2-4 OVERLAY	24.9 x ±11	271 sf	
REQD. MAX FLOOR AREA IN MX-8, MI-2/R6A (23-144, 23-942, 123-63)	2255 x 2.7 =	6088 sf	
REQD. MAX FLOOR AREA IN R6A/C2-4 OVERLAY (23-144, 23-942, 123-63)	271sf x 2.7 =	731 sf	
TOTAL REQ'D MAX FLOOR AREA	6088 + 731 =	6819 sf	
EXISTING FLOOR AREA	24.9 X ±101 =	2526 sf	
PROPOSED FLOOR AREA OF NEW ADDITION	24.9 X 50	1245 sf	
PROPOSED TOTAL FLOOR AREA	(24.9 X 101 EXIST. ) +	3783 sf	
	(24.9 X 50 PROPOSED) =	0,000	
REQD. MAX LOT COVERAGE IN MX-8, MI-2/R6A (23-145, 123-63, 77-24)	2255X 0.60 =	1353 sf	
REQD. MAX LOT COVERAGE IN R6A/C2-4 OVERLAY (23-145, 123-63, 77-24)	271 x 0.60 =	163 sf	
TOTAL REQ'D MAX LOT COVERAGE	1344 + 171 =	1516 sf	
PROPOSED LOT COVERAGE, RESIDENTIAL CONVERSION, NON-COMPLYING CONVERSION (123-67, 54-31)	24.9 X ±101 =	2526 sf	
REQD. REAR YD. (123-67, ZR-15, 54-31)	SEE NOTES ON LEFT - RESIDENTIAL CONVERSION	0' EXIST. ON 1ST FLR TO REMAIN	
PROPOSED REAR SETBACK OF NEW 2ND STORY ADDITION	51'-54' (VARIES) TO REAR LOT LINE OR 40'-43' (VARIES) TO DISTRICT BOUNDARY		
REQD. SIDEYARD, ZR123-651	NONE IN SPECIAL MIXED USE DISTRICTS & FOR SINGLE-FAM	0' IN EXISTG. BLDG, 0' IN PROPOSED ADDITION WHICH IS WHOLLY IN MX-8	
REQD. MAX # D.U. 23-22	2526 X 2.7 / 680 =	10	
PROPOSED # D.U.		1	
ACCESSORY OFF-STREET PARKING (123-72)	1 PER DWELLING UNIT REQ'D.	1 EXIST'G. PARKING SPACE PROVIDED	
ACCESSORY OFF-STREET BICYCLE PARKING (25-80)	1 PER 2 D.U. (WAIVED FOR 10 D.U. OR LESS)	N/A - LESS THAN 10 D.U.	
REQD. MAX HEIGHT/SET BACK (23-662, 77-28)	MAX BASE 60', MAX HEIGHT 70'	PROPOSED HEIGHT 28', NO SETBACK	
MIN. REQ'D LOT AREA FOR	1700 MIN. LOT AREA, 18'	· · · · · · · · · · · · · · · · · · ·	
RESIDENTIAL (23-32, 123.61)	MIN. LOT WIDTH REQ'D.		
REQD. USE, 77-11, 123-20	ALL USES PERMITT RESIDENTIAL DISTR	ED IN DESIGNATED ICT R6A PERMITTED	
PROPOSED USE	1 UNIT OF 'GENERAL' RE	SIDENCE, USE GROUP 2	
REQD. ENVIRONMENTAL CONDITIONS 123-32	ALL NEW WINDOWS SHA ATTENUATION, ALT VENTILATION THRO		
STREET TREES 28-03, 123-61, NY TREE PLANTING STANDARDS	50% PROPOSED INCREASE IN FLOOR AREA > 20° RE'QD: 1 TREE PER 25' FRONTAGE REQ'D. BECAUSE OF EXIST'G. LIGHT POST & CURB CUT OFFSITE TREE PROPOSED (SEE SITEPLAN, A-001		
REQ'D MINIMUM D.U. 28-21	6€0- <b>40</b> 6		
PROPOSED MINIMUM D.U. WINDOWS 28-22	42.5.12	SF , COMPLIES BE DOUBLE-GLAZED AS JIRED	
REFUSE STORAGE 28-23	N/A - LESS		
RECREATION SPACE 28-31	N/A - LESS	THAN 9 D.U.	

FIRE-RATING SUMMARY (TABLE 3-	4)
CONSTRUCTION CLASS I-C (2-hr PROTECTED), OCCUP	ANCY GROUP J-3
EXTERIOR BEARING WALLS @ LOT LINE	2 HR
EXTERIOR NON-LOAD BEARING WALLS @ FACADE AND REAR OVER 30' SEPARATION	N.L.
INTERIOR BEARING WALLS & PARTITIONS	2 HR
COLUMNS SUPPORTING MORE THAN ONE FLOOR	2 HR
FLOOR CONSTRUCTION	1½ HR
ROOF CONSTRUCTION	1 HR

### **ABBREVIATIONS**

handicap

insulation

low-voltage

maximum

microwave

mounted

painted

quantity

register

REQ'D. required

room

soffit

steel tread

top of

to remain

underside

verify in field

water closet

washing machine

vertical

wood

window

Z.C.C zinc-coated copper

typical

similar

reinforce

rough opening

roof rafters

specification

stainless steel

to be determined

tongue in groove

thick / thickness

unless noted otherwise

vinyl composition tile

not to scale on center

pressure treated

location / locate

INSUL.

LOC.

MAX.

NTS

PT'D.

P.T.

QTY.

REG.

R.0.

SIM.

SOF.

SPEC.

SS

STL.

T.B.D.

T&G

THK.

T.0.

T.R.

TYP.

VERT.

WNDW.

AS PER

ART 1. CHS

REINF.

### SYMBOLS

ADD'L AFF AHU ANOD.	additional above finished floor air handling unit anodized	101) = D00R #	
B.O. CAB. CEIL'G. CL	by others cabinet ceiling center line	10 A601 = DETAIL 2 A30	
CLR.	clear		
CMU C.O. COL.	concrete masonry unit cleanout column	10'-0"	= CEILING HGT. AFF
CONC. C.P. D.	concrete compactor dryer	5/A201	= INTERIOR ELEVATION DWG. # / SHEET
DBL.	double	^	= CUT LINE
DIA.	diameter		= COT LINE
DIR.	direction		
DN DR.	down door		= NEW INTERIOR PARTITION
D.W.	dishwasher		
D.W. DWG.	drawing	<del></del>	2 MD DATED WALL
ELEC.	electrical		= 2-HR RATED WALL
ELEV.	elevation		
EQ.	equal		= EXIST. INTERIOR PARTITION
EQUIP.	equipment		TO REMAIN
EXIST.	existing		TO RETURN
EXT.	exterior	<del></del>	= EXIST. INTERIOR PARTITION
FF	finished floor		TO BE DEMOLISHED
FIN.	finished		
FIXT.	fixture		
FLR.	floor	/	= H.C. CLEARANCE 30" x 48"
FLUOR.	flourescent		- M.C. CZEANANCE SV A 40
FDN.	foundation		
GEN.	general	k´	
GWB	gypsum wall board		
HVAC	heat / vent / air-condit	ion	

# HSU LOFT

7/04)

= APPD. TYPE COMBINATION

MONOXIDE DETECTOR (PER LL

SMOKE DETECTOR (PER

LL62/81) & CARBON

## 94 N. 1st STREET BROOKLYN, NY

### DRAWING LIST:

A000	COVER SHEET
	SURVEY
	RESCHECK COMPLIANCE CERTIFICAT
A001	SITE PLAN
D101	DEMO PLAN
A101	NEW WORK PLAN

PLUMBING RISER DIAGRAM/ GAS RISER DIAGRAM

**NEW WORK ROOF PLAN/** 

GAS RISER DIAGRAM

A201 SECTIONS/ELEVATIONS
A401 WALL SECTIONS

S101 STRUCTURAL PLANS

STRUCTURAL PLANS/ SECTION



BUNGAN TANK TANKAN

**S** s **D** 

325 W 38TH STREET, SUITE 210 NEW YORK, NY 10018

tel: 212, 248, 7500 fax: 866, 677, 3878 www.ssdarchitecture.com info@ssdarchitecture.com

STRUCTURAL ENGINEER:

CONSULTANTS:

Richard H. Balser, Engineers 228 W 18th Street, No. 11 New York, NY 10011

212-463-0008

SURVEYOR:
Leonard J. Strandberg and A

Leonard J. Strandberg and Associates Consulting Engineers and Land Surveyors, P.C. 92 Atlantic Avenue, Freeport, NY 11520 516-378-2064 212-213-4090 fax 516-378-6649


PROJECT: HSU LOFT

PROJECT ADDRESS:

94 NORTH FIRST STREET
BROOKLYN, NY 11211

OWG TITLE
TITLE PAGE

SEAL & SIGNATURE:

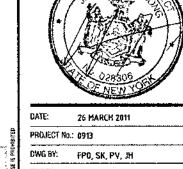

PROJECT NO.: 0913

DWG BY: FPO, SK, PV, JH


CHK BY: JH, JP

DWG No.:


A-000.0

DOB ID No.:

| PAGE No.: | PAGE No.: | 1 OF 10

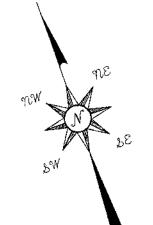

### NORTH 1ST STREET

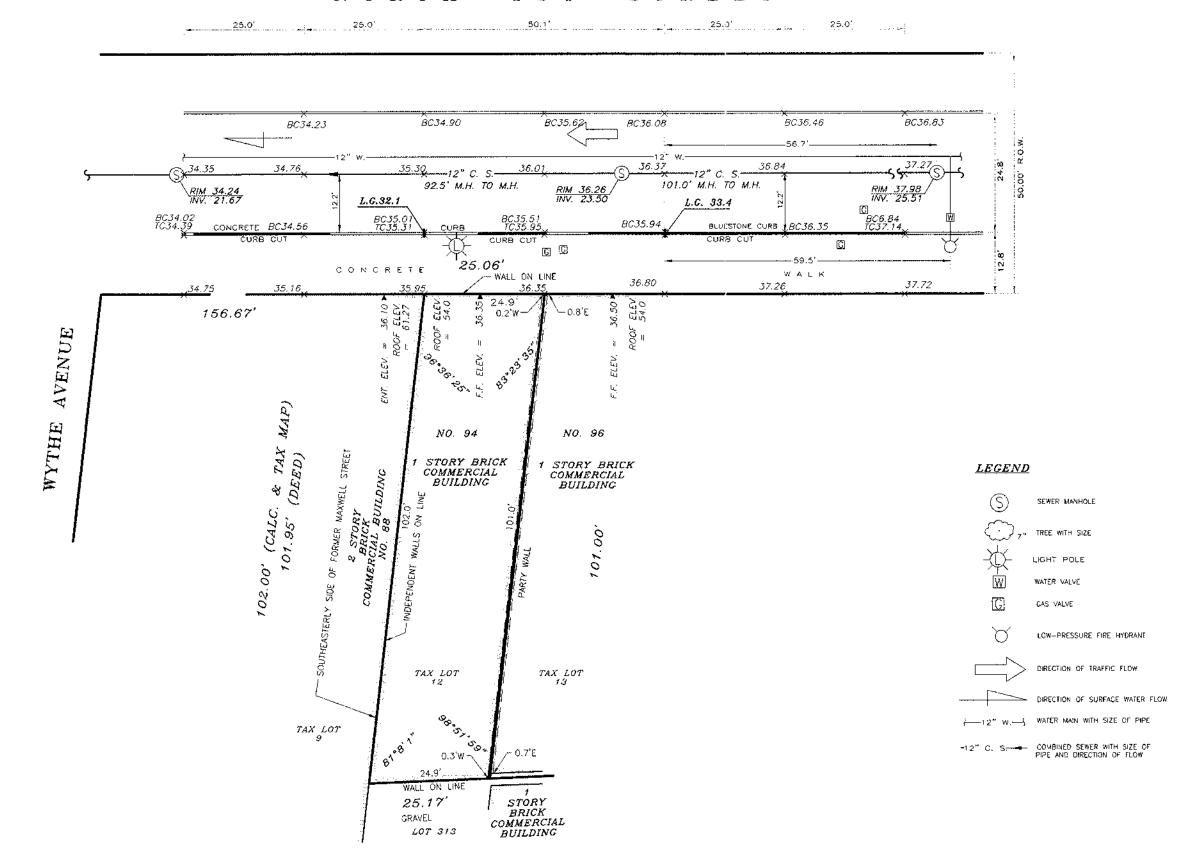

### ARCHITECTURAL SURVEY

OF LOT NO.'s 310 AND 312 IN BLOCK NO. 2379 "MAP OF THE TOWN OF WILLIAMSBURGH" FILED MAP NO. 507

LOCATED AT:
BOROUGH OF BROOKLYN, COUNTY OF KINGS, CITY AND STATE OF NEW YORK

TAX DESIGNATION:

BLOCK: 2379 LOT: 12

SURVEYED ON : AUGUST 26, 2005 AMENDED ON: JANUARY 18, 2011 (UPDATE)


1) ELEVATIONS AND ESTABLISHED GRADES SHOWN HEREON REFER TO THE BOROUGH OF BROOKLYN HIGHWAY DEPARTMENT DATUM WHICH IS 2.56 FEET ABOVE NGVO MEAN SEA LEVEL DATUM, 1929 AT SANDY HOOK, AND 0.84 FEET ABOVE BROOKLYN SEWER DATUM

- LECAL GRADES SHOWN HEREON REFER TO THE TOP OF THE CURB TAKEN AT THE PROJECTION OF THE PROPERTY LINES.
- THE INFORMATION GIVEN ON THIS SURVEY PERTAINING TO UTILITIES AND/OR SUBSTRUCTURES IS NOT CERTIFIED AS 70 ACCURACY OR COMPLETENESS.
- 4) NO UTILITY AND/OR SUBGRADE INFORMATION OTHER THAN SEWER AND WATER IS INDICATED ON THIS SURVEY. CONSULT WITH THE APPROPRIATE UTILITY COMPANY OR AGENCY PRIOR TO DESIGNING IMPROVEMENTS.
- 5) SIZES AND TYPES OF SEWERS SHOWN HEREON AS OBTAINED FROM THE BOROUGH OF BROOKLYN SEWER DEPARTMENT RECORDS. SEWER MANHOLS RIM AND INVERT ELEVATIONS SHOWN HEREON OBTAINED BY FIELD
- 6) SIZE OF WATER MAIN SHOWN HEREON AS OBTAINED FROM THE CITY OF NEW YORK DEPARTMENT OF ENVIRONMENTAL PROTECTION RECORDS, AS SHOWN ON MAP DDM K25-01
- 7) THE OWNER, CONTRACTOR AND/OR HIS AGENTS MUST NOTIFY THE APPROPRIATS UTILITY COMPANIES AND/OR AGENCIES AT LEAST 72 HOURS PRIOR TO ANY CONSTRUCTION IN ACCORDANCE WITH INDUSTRIAL CODE RULE 53.
  - 8) THIS IS TO CERTIFY THAT THERE ARE NO STREAMS NOR NATURAL WATERCOURSES IN THE PROPERT AS SHOWN ON THIS SURVEY.
  - 9) TOTAL AREA OF THE PARCEL = 2526.70 SQ.FT. = 0.058 ACRE.

UNAUTHORIZED ALTERATION OR ADDITION TO THIS SURVEY IS A VIOLATION OF SECTION 7209 OF THE NEW YORK STATE EDUCATION LAW. COPIES OF THIS SURVEY MAP NOT BEARING THE LAND SURVEYOR'S INKED SEAL OR EMBOSSED SEAL SHALL NOT BE CONSIDERED TO BE A VALID TRUE COPY.

CERTIFICATION INDICATED HEREON SHALL RUN ONLY TO THE PERSON FOR WHOM THE SURVEY IS PREPARED, AND ON HIS BEHALF TO THE TITLE COMPANY, GOVERNMENTAL AGENCY AND LENDING INSTITUTION LISTED HEREON, AND TO THE ASSIGNEES OF THE LENDING INSTITUTION, CERTIFICATIONS ARE NOT TRANSFERABLE TO ADDITIONAL

INSTITUTIONS OR SUBSEQUENT OWNERS. THE EXISTANCE OF RIGHT OF WAYS AND/OR EASEMENTS OF RECORD, IF ANY, NOT SHOWN ARE NOT CERTIFIED.

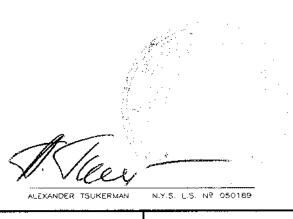


CHECKED BY: AT DRAWN BY: JR/M.K.

Scale 1" = 20'

The state of the s

LEONARD J. STRANDBERG AND ASSOCIATES, consulting engineers and land surveyors, p.c. 32 SMITH STREET, FREEPORT, NY 11520 516-378-2064 ° 212-213-4090 ° FAX 516-378-6649 ONE EDGEWATER PLAZA, STATEN ISLAND, NY 10305 Suite 205 ° 718-420-9693 ° FAX 718-420-9673

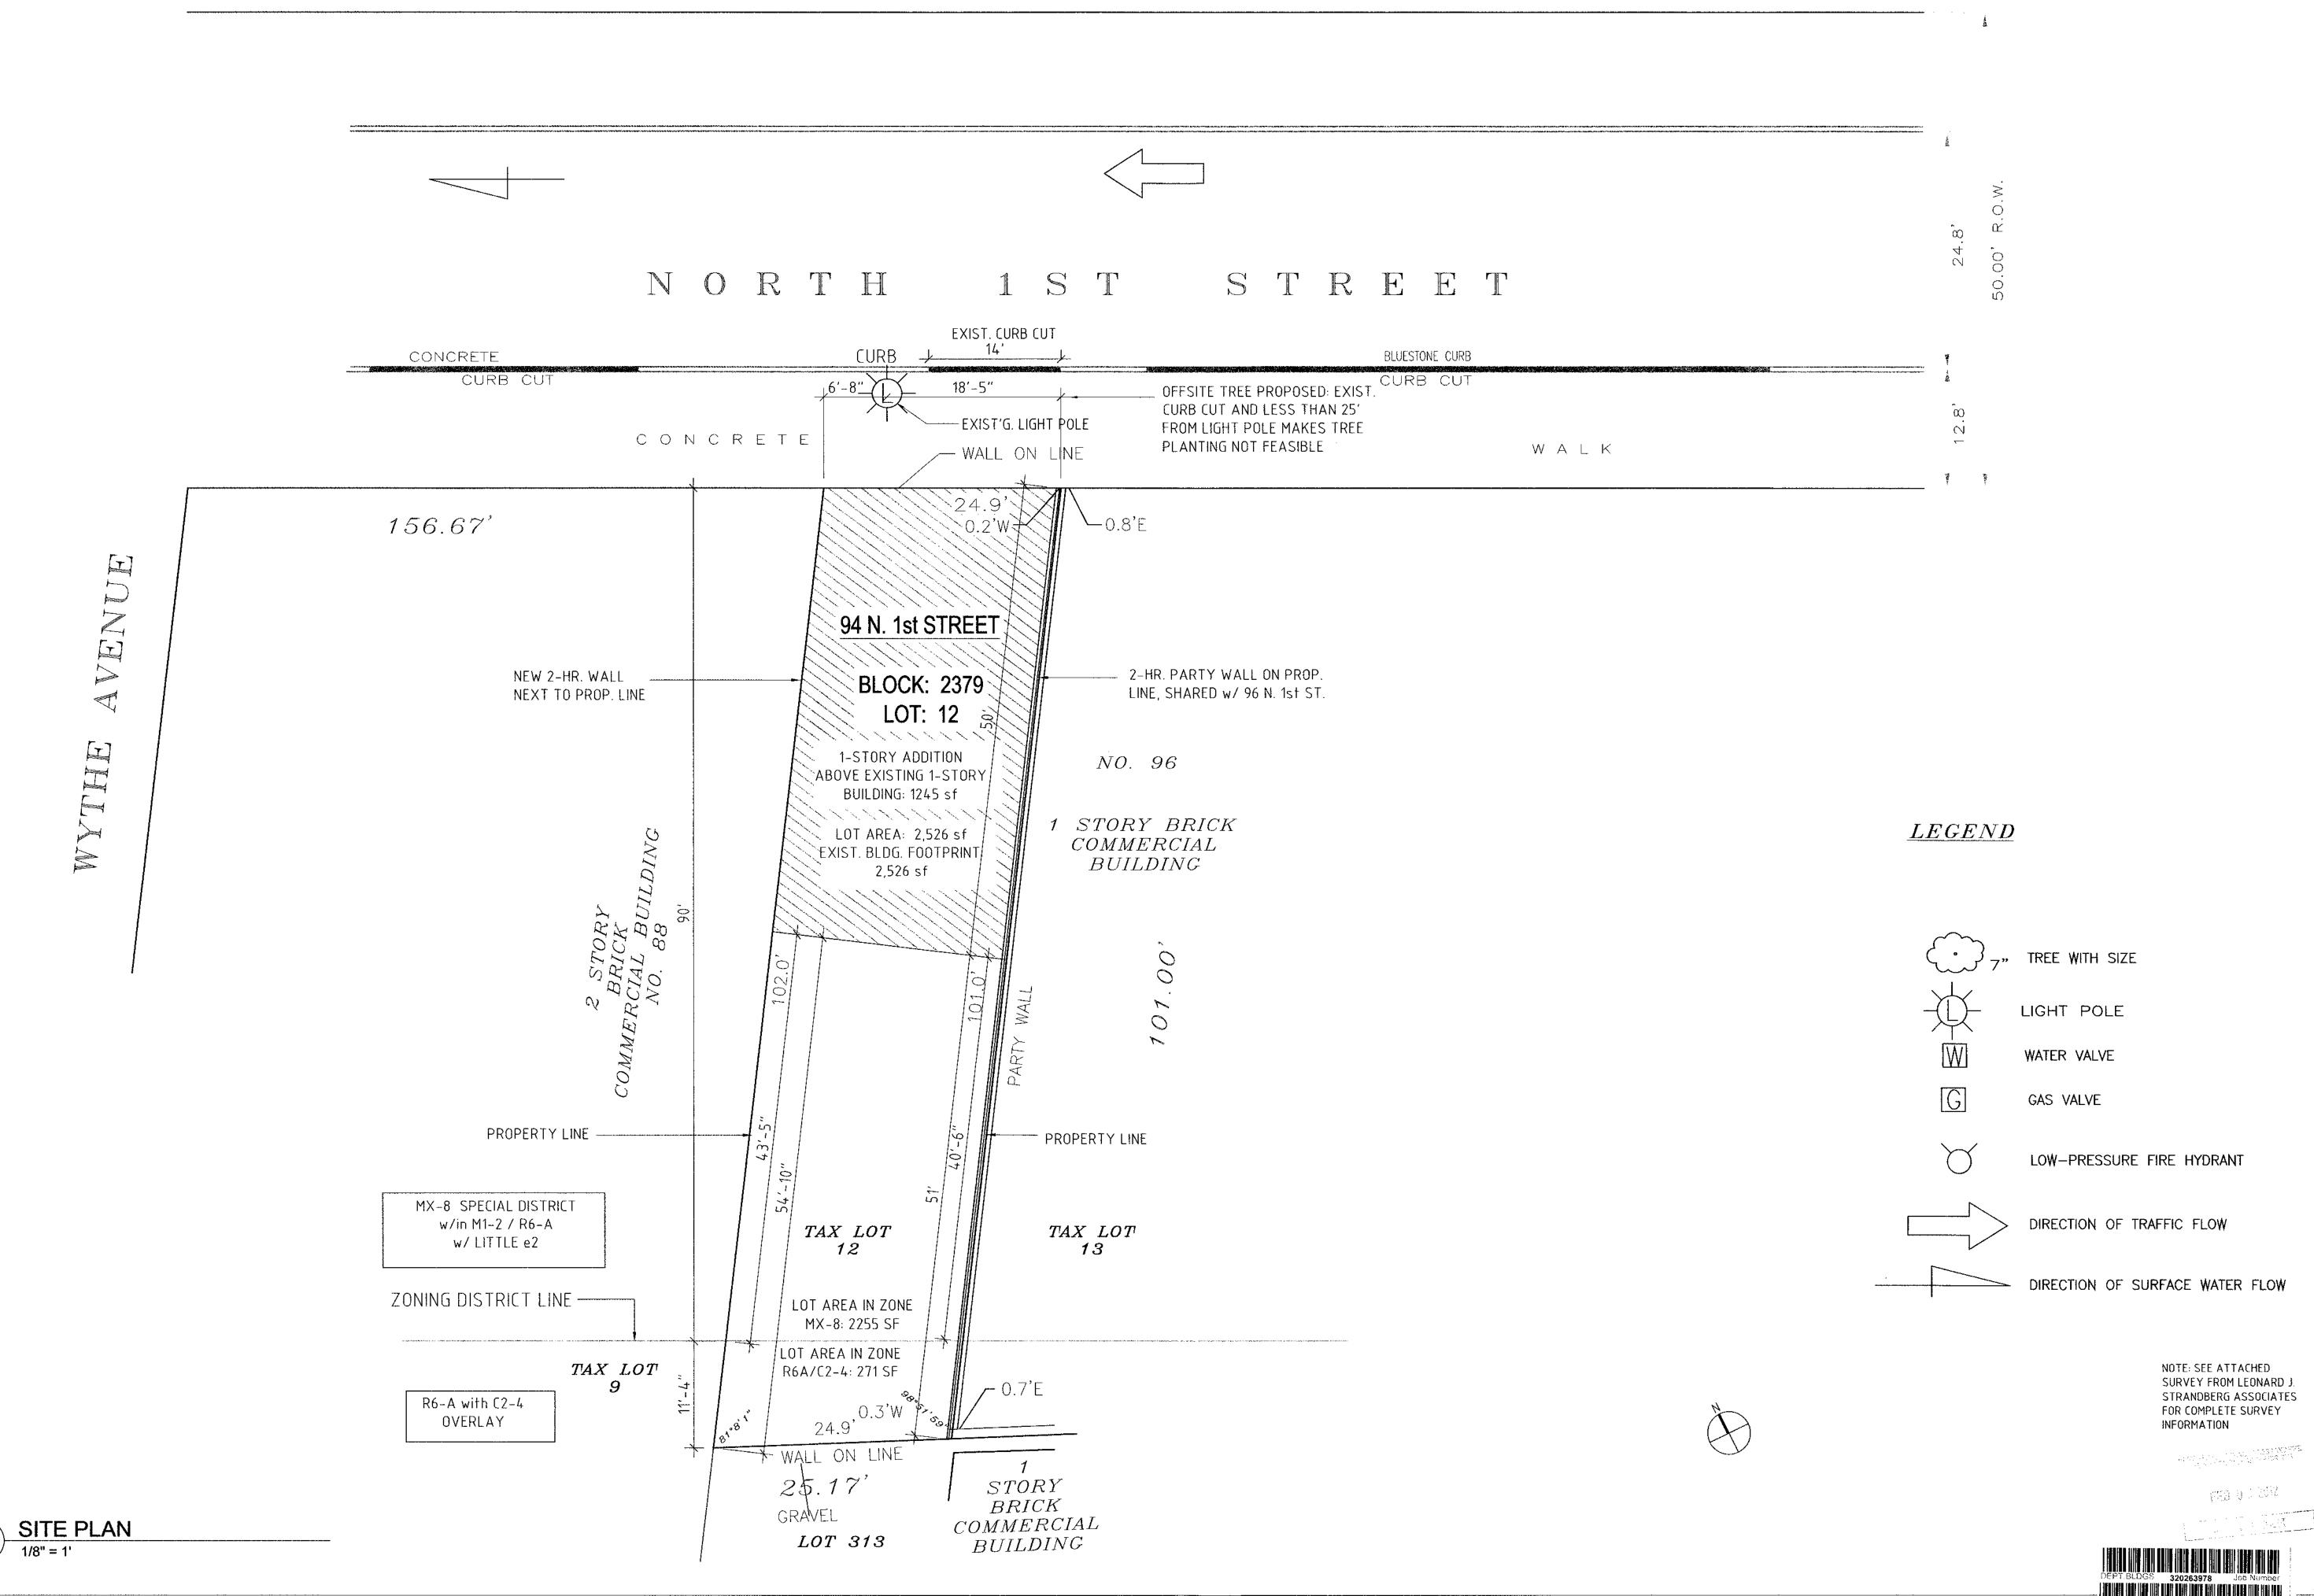

S s D

325 W 38TH STREET, SUITE 210 NEW YORK, NY 10018

tel: 212, 248, 7500 fax: 866, 677, 3878 www.ssdarchitecture.com info@ssdarchitecture.com

CONSULTANTS:

STRUCTURAL ENGINEER: Richard H. Balser, Engineers 228 W 18th Street, No. 11 New York, NY 10011 212-463-0008

SURVEYOR: Leonard J. Strandberg and Associates Consulting Engineers and Land Surveyors, P.C. 92 Atlantic Avenue, Freeport, NY 11520 516-378-2064 212-213-4090 fax 516-378-6649

PROJECT: HSU LOFT

PROJECT ADDRESS:

94 NORTH FIRST STREET
BROOKLYN, NY 11211

OWS TITLE: SITE PLAN



DATE: 26 MARCH 2011

PROJECT No.: 6913


DWG BY: FPO, SK, PV, JH

СНК ВУ: JH, JP


DWG No:

A-001.0

**\-001.00**BID NO.: PAG
2 0;

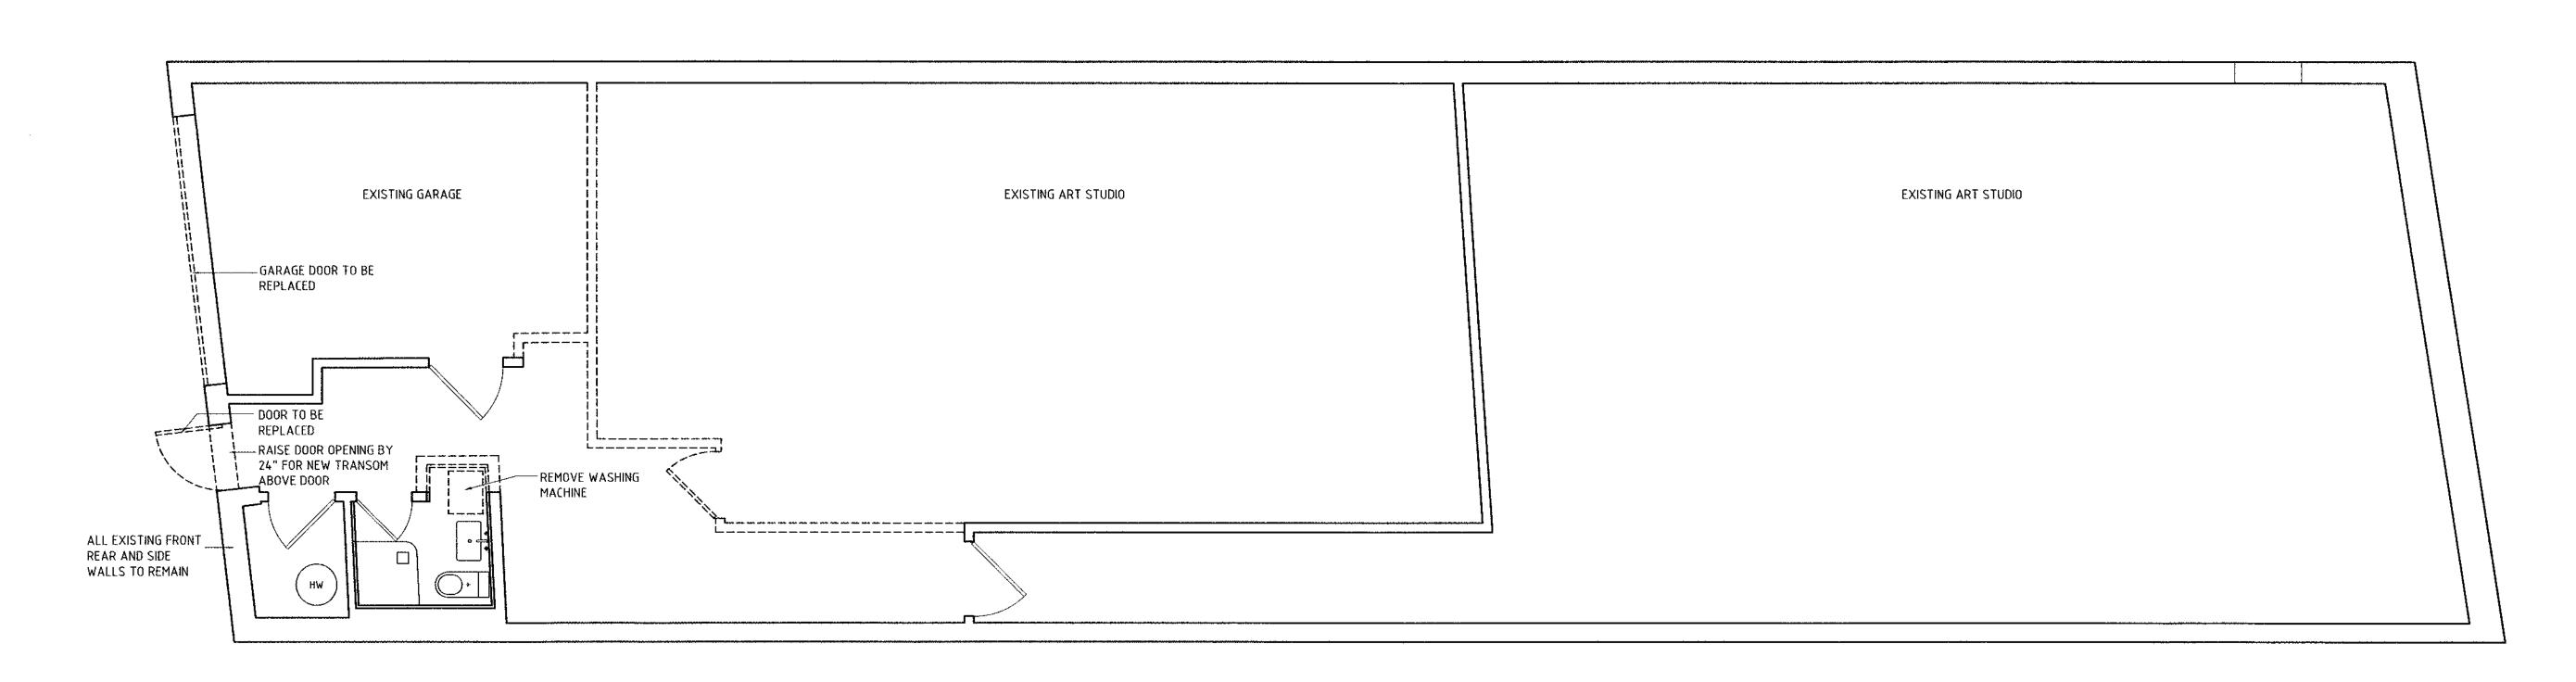

1ST FLOOR DEMO PLAN
1/4" = 1'

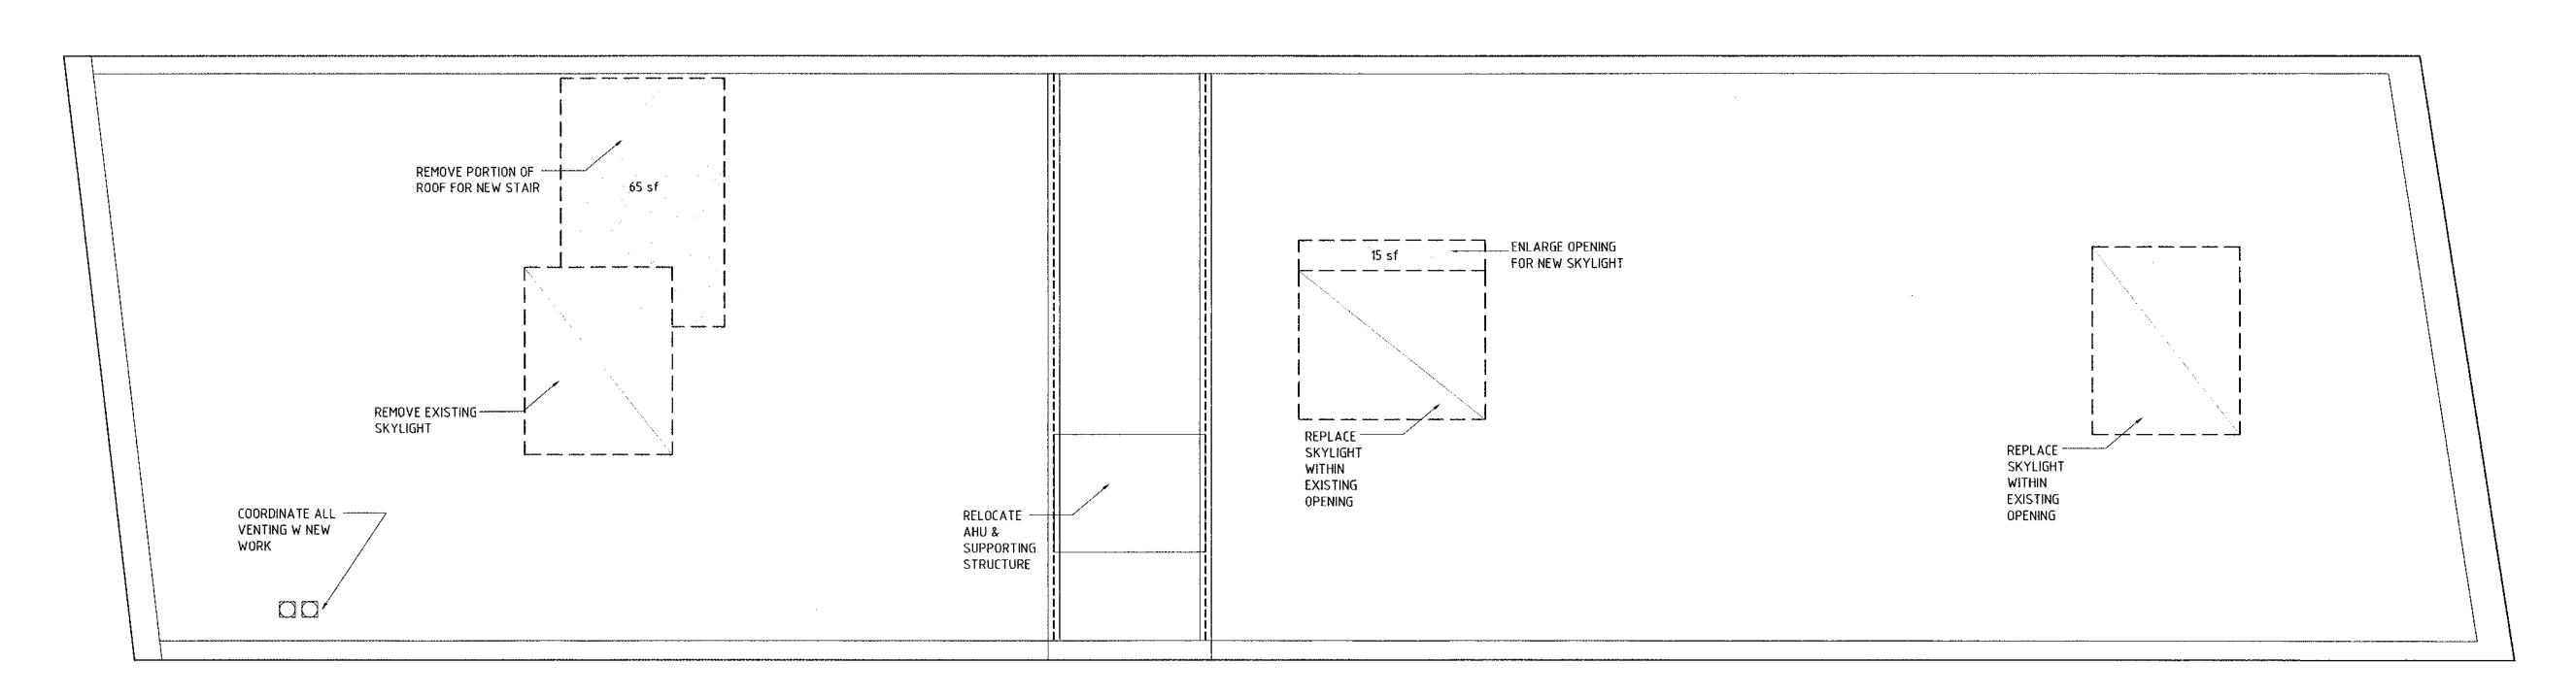

AREA CALCUI	_ATIONS OF EXTERIO	R WALLS/ROOF TO BE	REMOVED
	EXISTING AREA	AREA TO BE REMOVED	% REMOVED
FRONT WALL	24.9 x 15.5 = 386sf	3.2 x 2 = 7sf	2%
REAR WALL	24.9 x 15.5 = 386sf	0sf	0%
SIDE WALL WEST	102 x 15.5 = 1581sf	0sf	0%
SIDE WALL EAST	101 x 15.5 = 1581sf	0sf	0%
ROOF	24.9 X 101 = 2526sf	80sf	3%
TOTAL	6450sf	87sf	1.3%

<u>LEGEND</u> \_\_\_\_ WALLS/OBJECTS TO BE REMOVED SURFACES TO BE REMOVED

DEMO NOTES

- 1. ALL DEMO WORK TO BE COORDINATED W/ LICENSED PLUMBER & ELECTRICIAN.
- 2. PROTECT ALL AREAS THAT ARE NOT TO DEMO'D. 3. PATCH/REPAIR ALL AREAS EXPOSED BY
- DEMO WORK THAT WILL NOT BE COMPLETELY HIDDEN BY NEW WORK. 4. NO CHIPPING/CHANNELING OF UNDERLYING

STRUCTURAL/ FIRE-RATED MATERIALS

17503 AND 573 50 R 315 PHE 0 & 2012





2 ROOF (2ND FLR) DEMO PLAN
1/4" = 1'

**S** s **D** 

325 W 38TH STREET, SUITE 210 NEW YORK, NY 10018

tel: 212, 248, 7500 fax: 866, 677, 3878 www.ssdarchitecture.com info@ssdarchitecture.com

CONSULTANTS:

STRUCTURAL ENGINEER; Richard H. Balser, Engineers 228 W 18th Street, No. 11 New York, NY 10011 212-463-0008

SURVEYOR: Leonard J. Strandberg and Associates Consulting Engineers and Land Surveyors, P.C. 92 Atlantic Avenue, Freeport, NY 11520 516-378-2064 212-213-4090 fax 516-378-6649


HSU LOFT


PROJECT ADDRESS: 94 NORTH FIRST STREET BROOKLYN, NY 11211

DEMO PLAN, 1ST FLR, ROOF



PROJECT No.: 0913 DWG BY: FPO, SK, PV, JH
CHK 8Y: JH, JP
DWG No.:

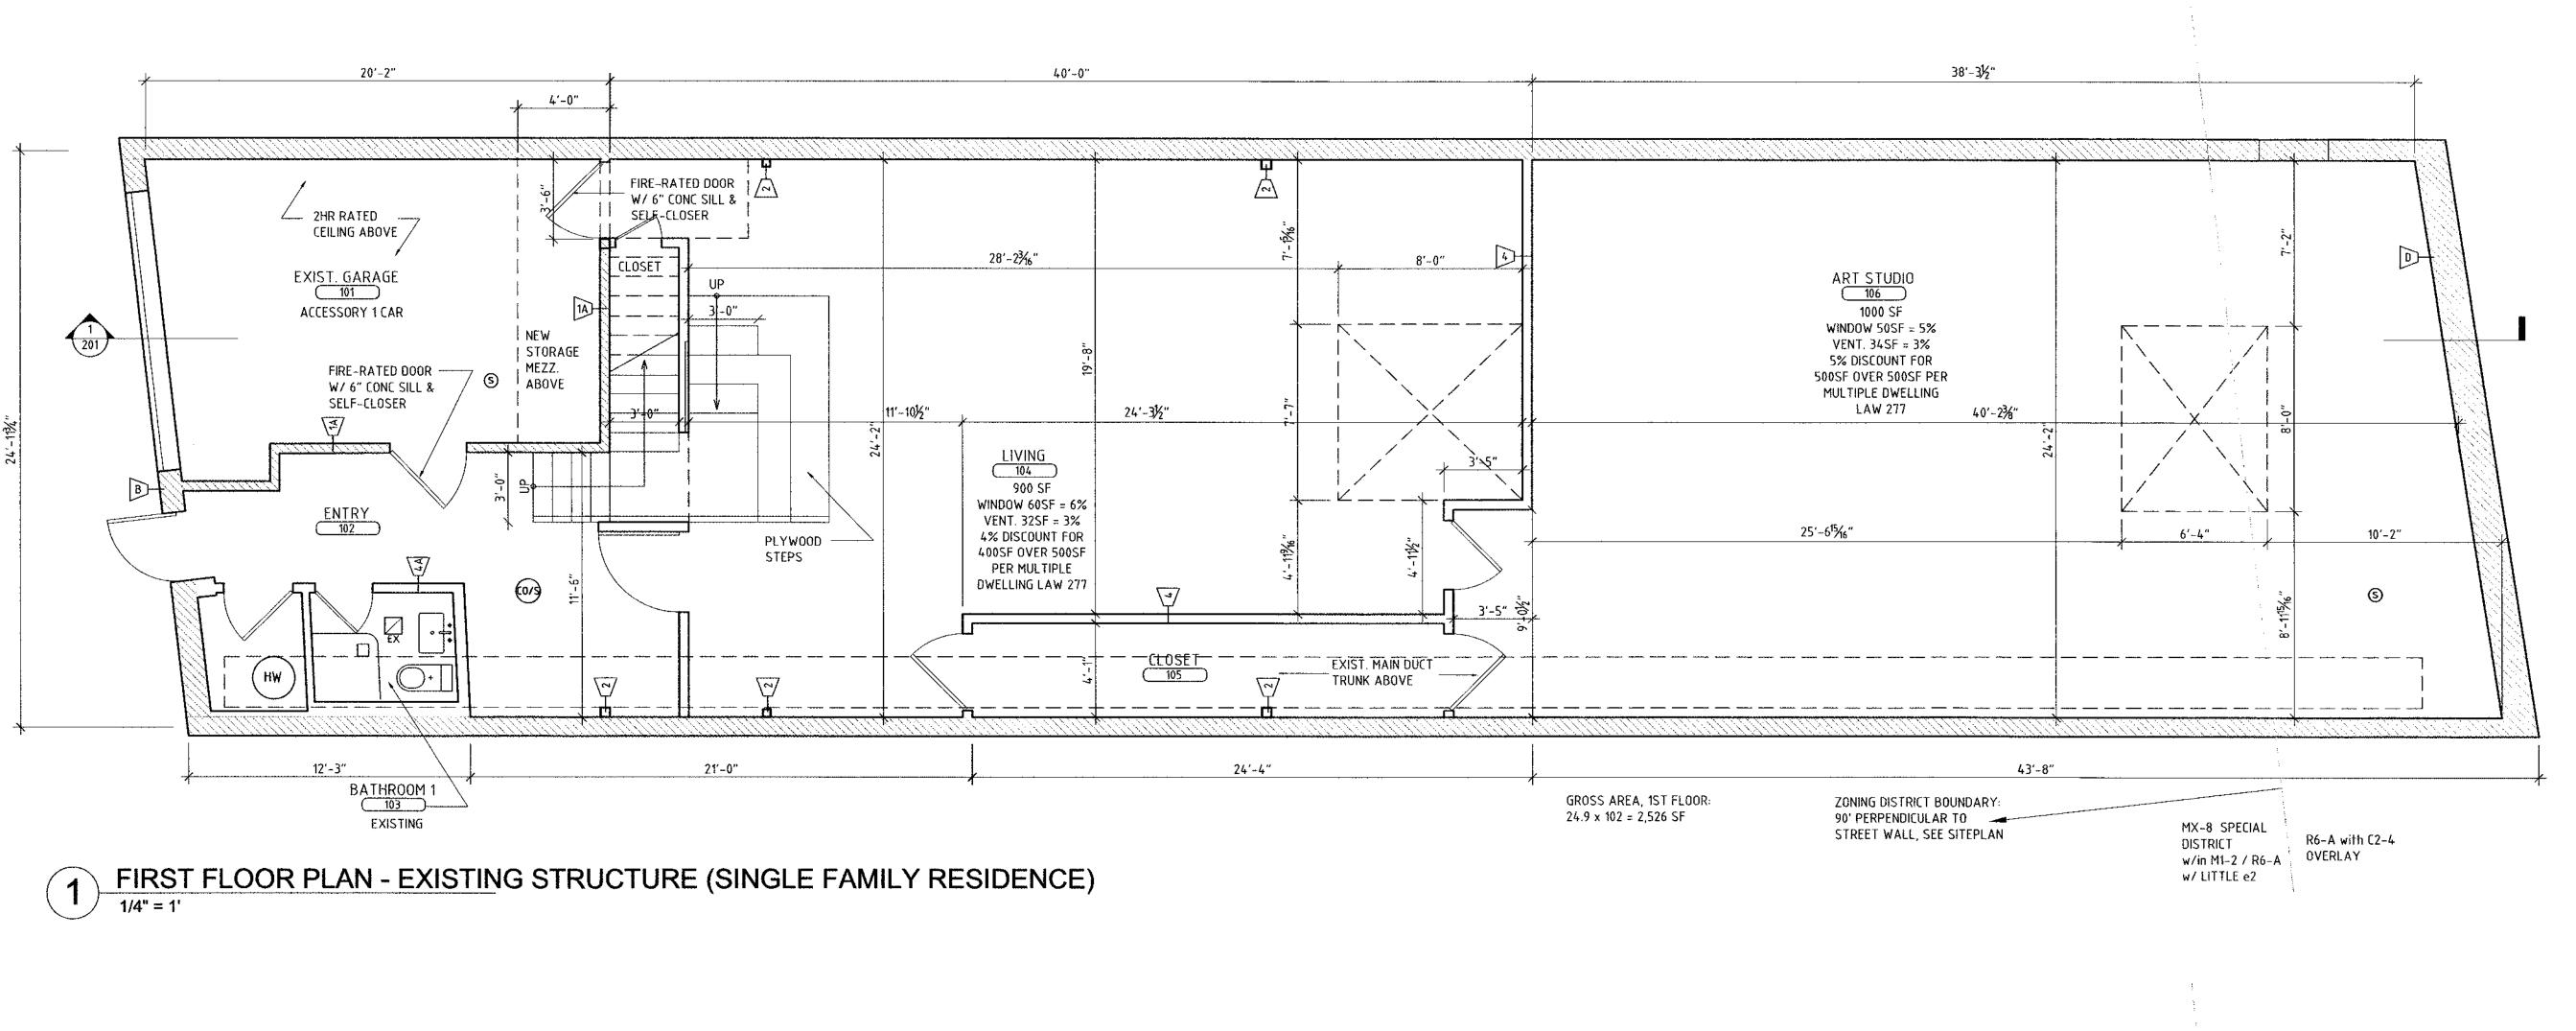

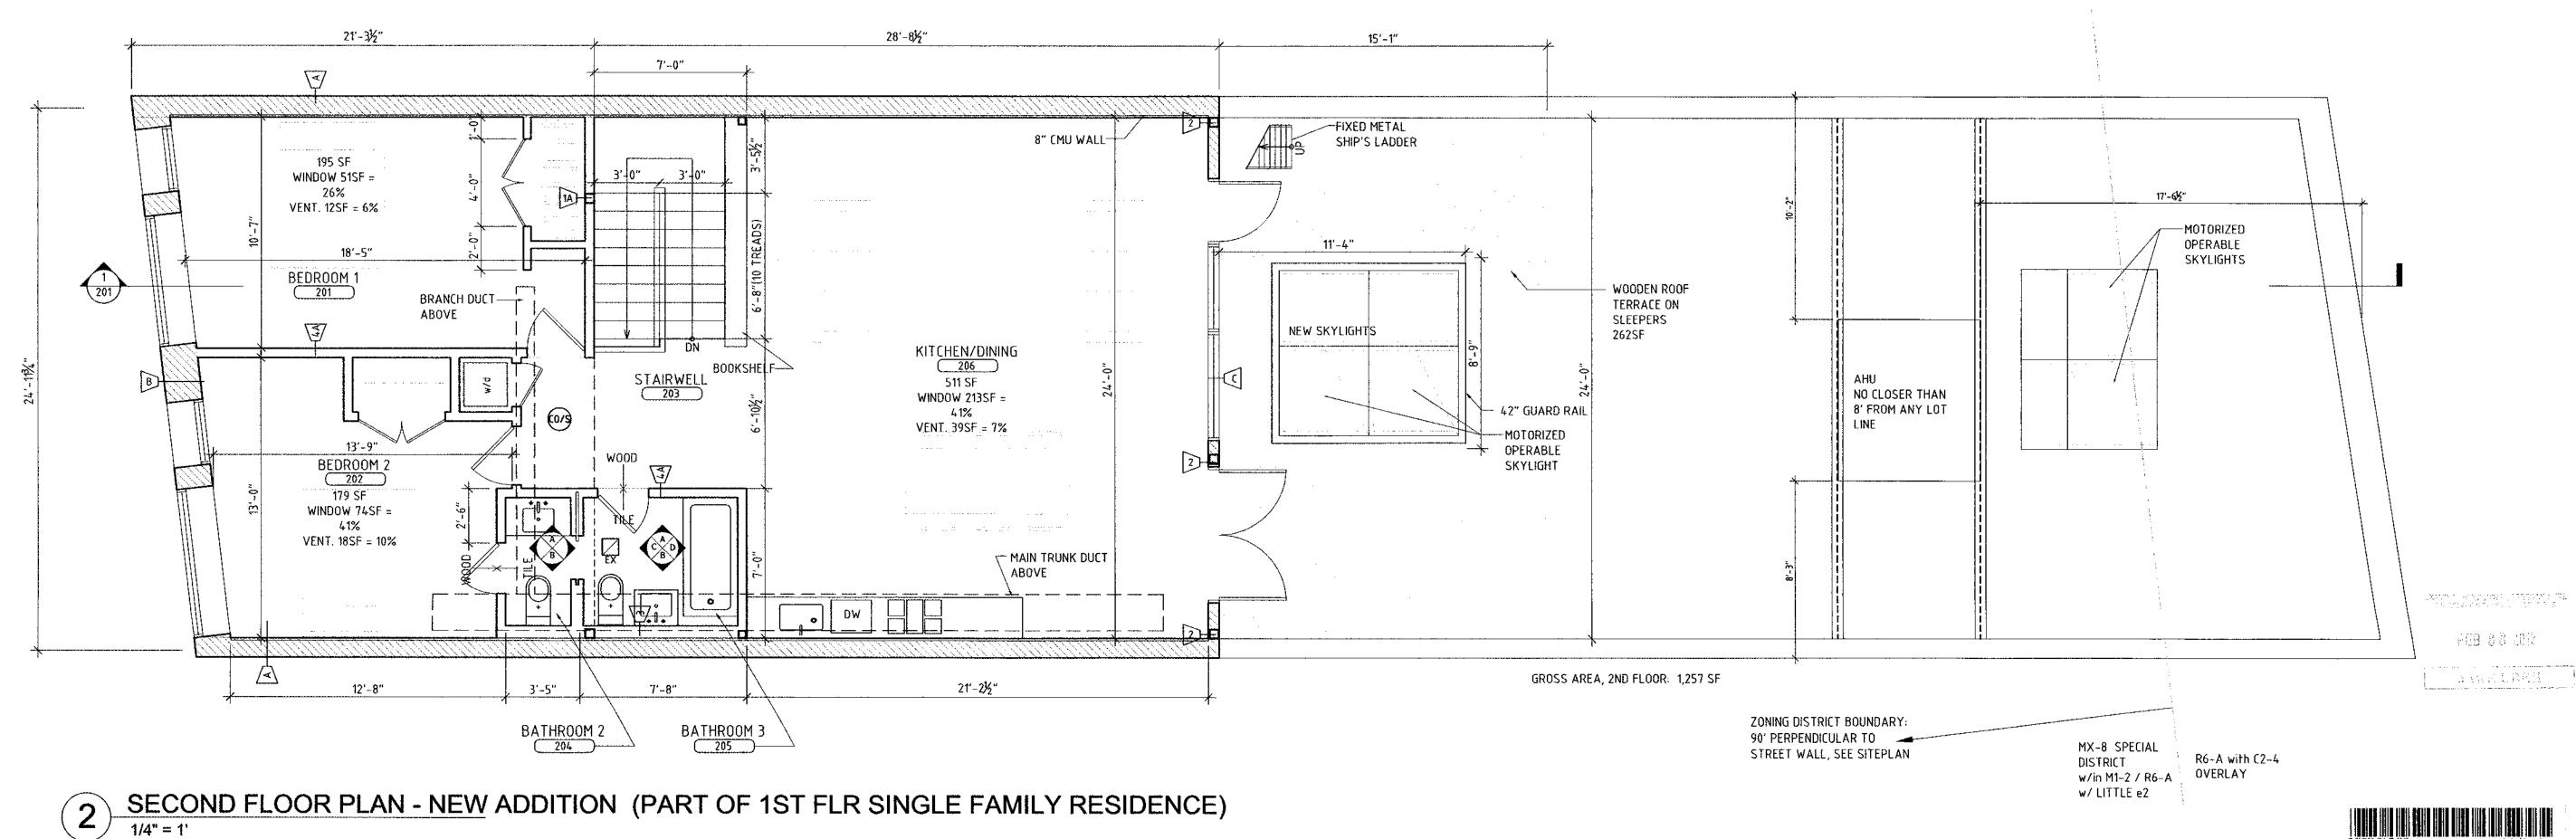

**S** s **D** 

325 W 38TH STREET, SUITE 210 NEW YORK, NY 10018

tel: 212, 248, 7500 fax: 866, 677, 3878 www.ssdarchitecture.com info@ssdarchitecture.com


STRUCTURAL ENGINEER: Richard H. Balser, Engineers 228 W 18th Street, No. 11 New York, NY 10011 212-463-0008

SURVEYOR: Leonard J. Strandberg and Associates
Consulting Engineers and
Land Surveyors, P.C.
92 Atlantic Avenue, Freeport, NY 11520
516-378-2064 212-213-4090 fax 516-378-6649

**HSU LOFT** 


94 NORTH FIRST STREET BROOKLYN, NY 11211

DWG TITLE: NEW WORK PLANS, 1ST FLR, 2ND FLR

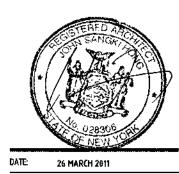

PROJECT No.: 0913
DWG BY: FPO, SK, PV, JH CHK BY: JH, JP


PAGE No.: 4 OF 10

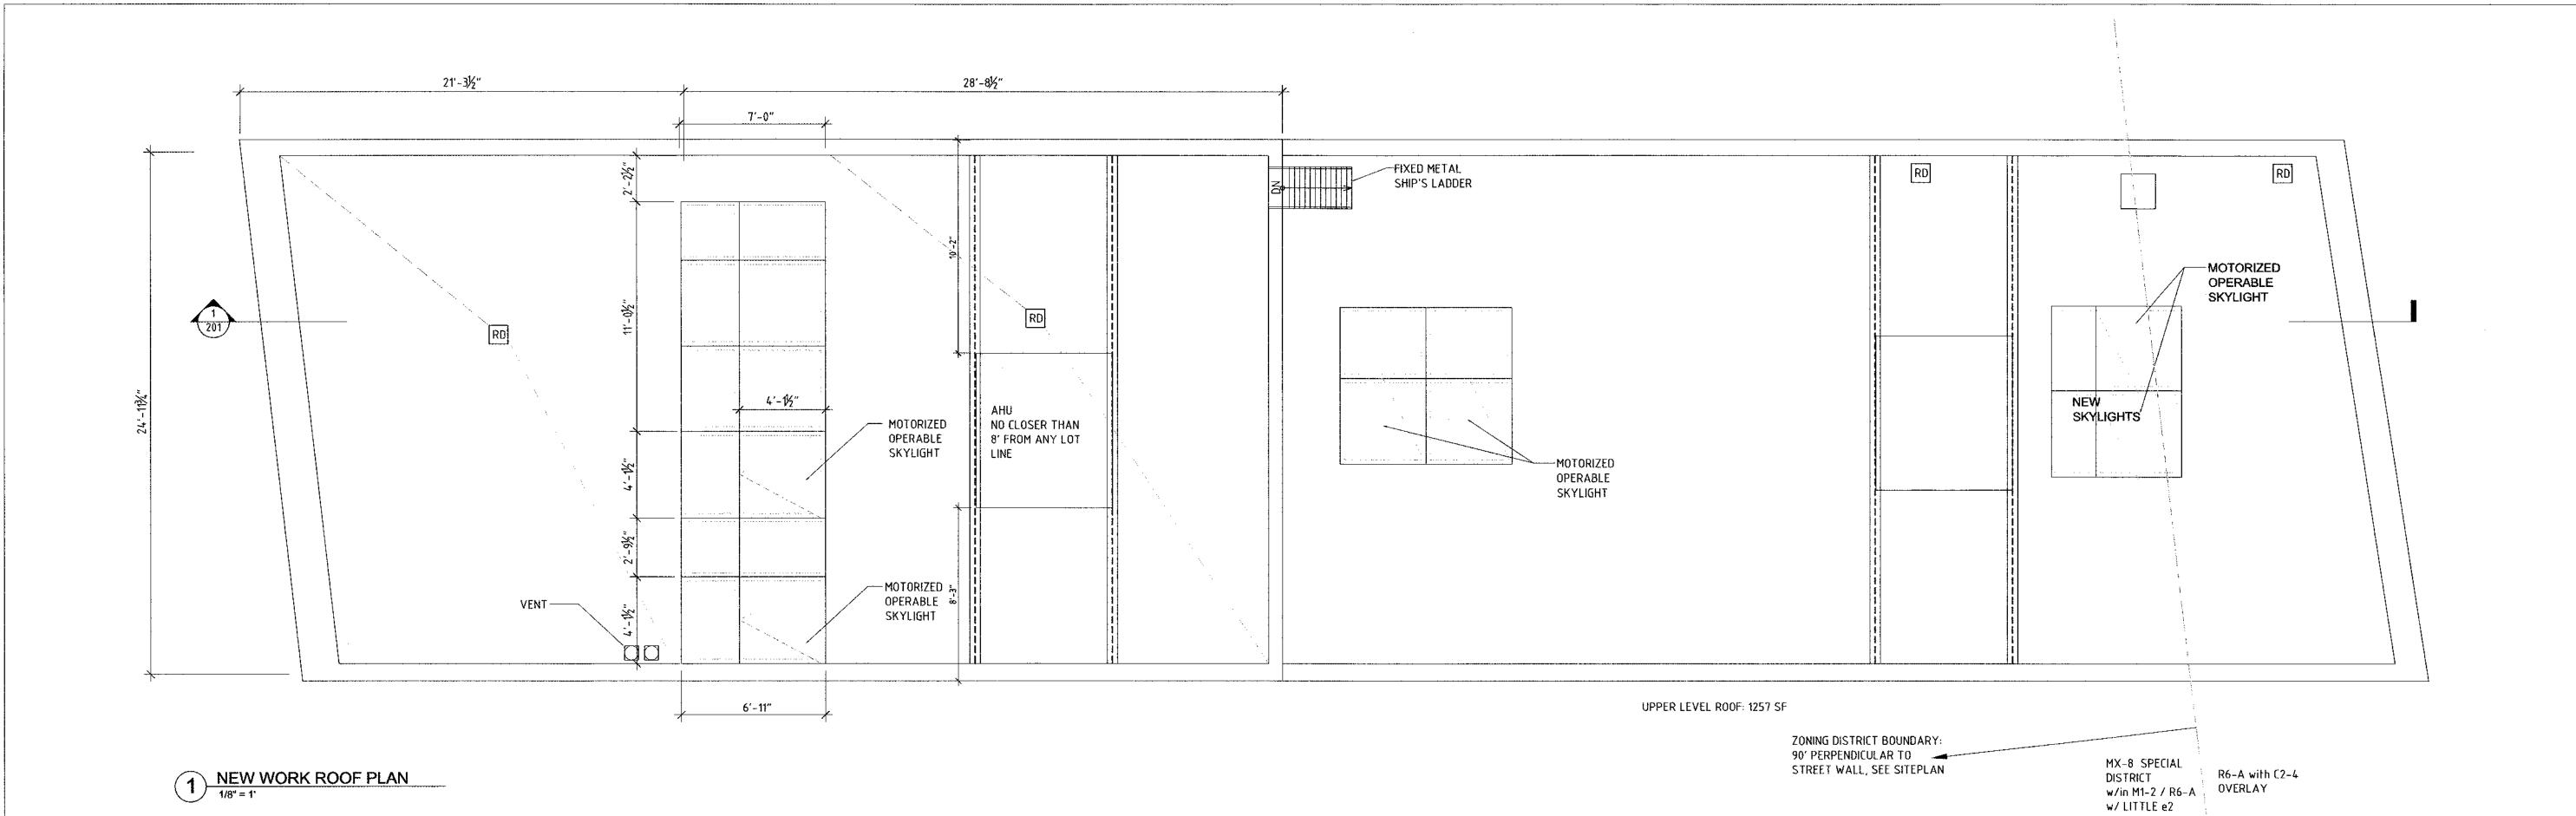

PROFITOR

PROFIT

2 PLUMBING RISER DIAGRAM
NA

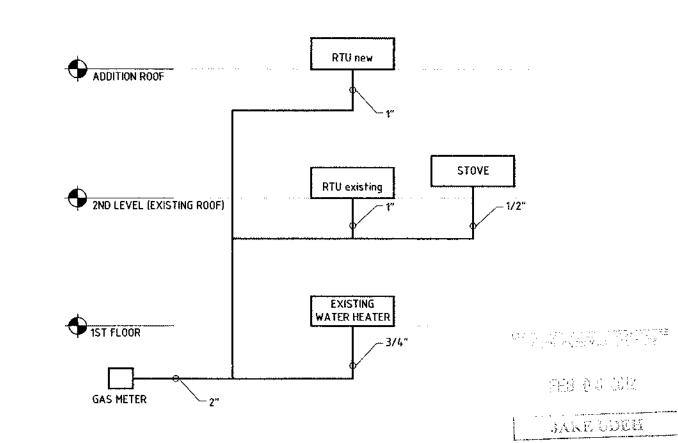

3 GAS RISER DIAGRAM



S s D

325 W 38TH STREET, SUITE 210 NEW YORK, NY 10018

tel: 212, 248, 7500 fax: 866, 677, 3878 www.ssdarchitecture.com

CONSULTANTS:

STRUCTURAL ENGINEER: Richard H. Balser, Engineers 228 W 18th Street, No. 11 New York, NY 10011 212-463-0008

SURVEYOR: Leonard J. Strandberg and Associates Consulting Engineers and Land Surveyors, P.C. 92 Atlantic Avenue, Freeport, NY 11520 516-378-2064 212-213-4090 fax 516-378-6649

PROJECT: HSU LOFT

PROJECT ADDRESS: 94 NORTH FIRST STREET BROOKLYN, NY 11211

DWG TITLE:
ROOF PLAN &
PLUMBING RISER
DIAGRAM



DATE: 26 MARCH 2011
PROJECT No.: 0913
DWG BY: FPO, SK, PV, JH

DWG BY: FPO, SK, PV, JH


CHK BY: JH, JP


DWG No.:

A-102.01

A-102.01

DOBID No.: PAGE No.: 5 OF 10

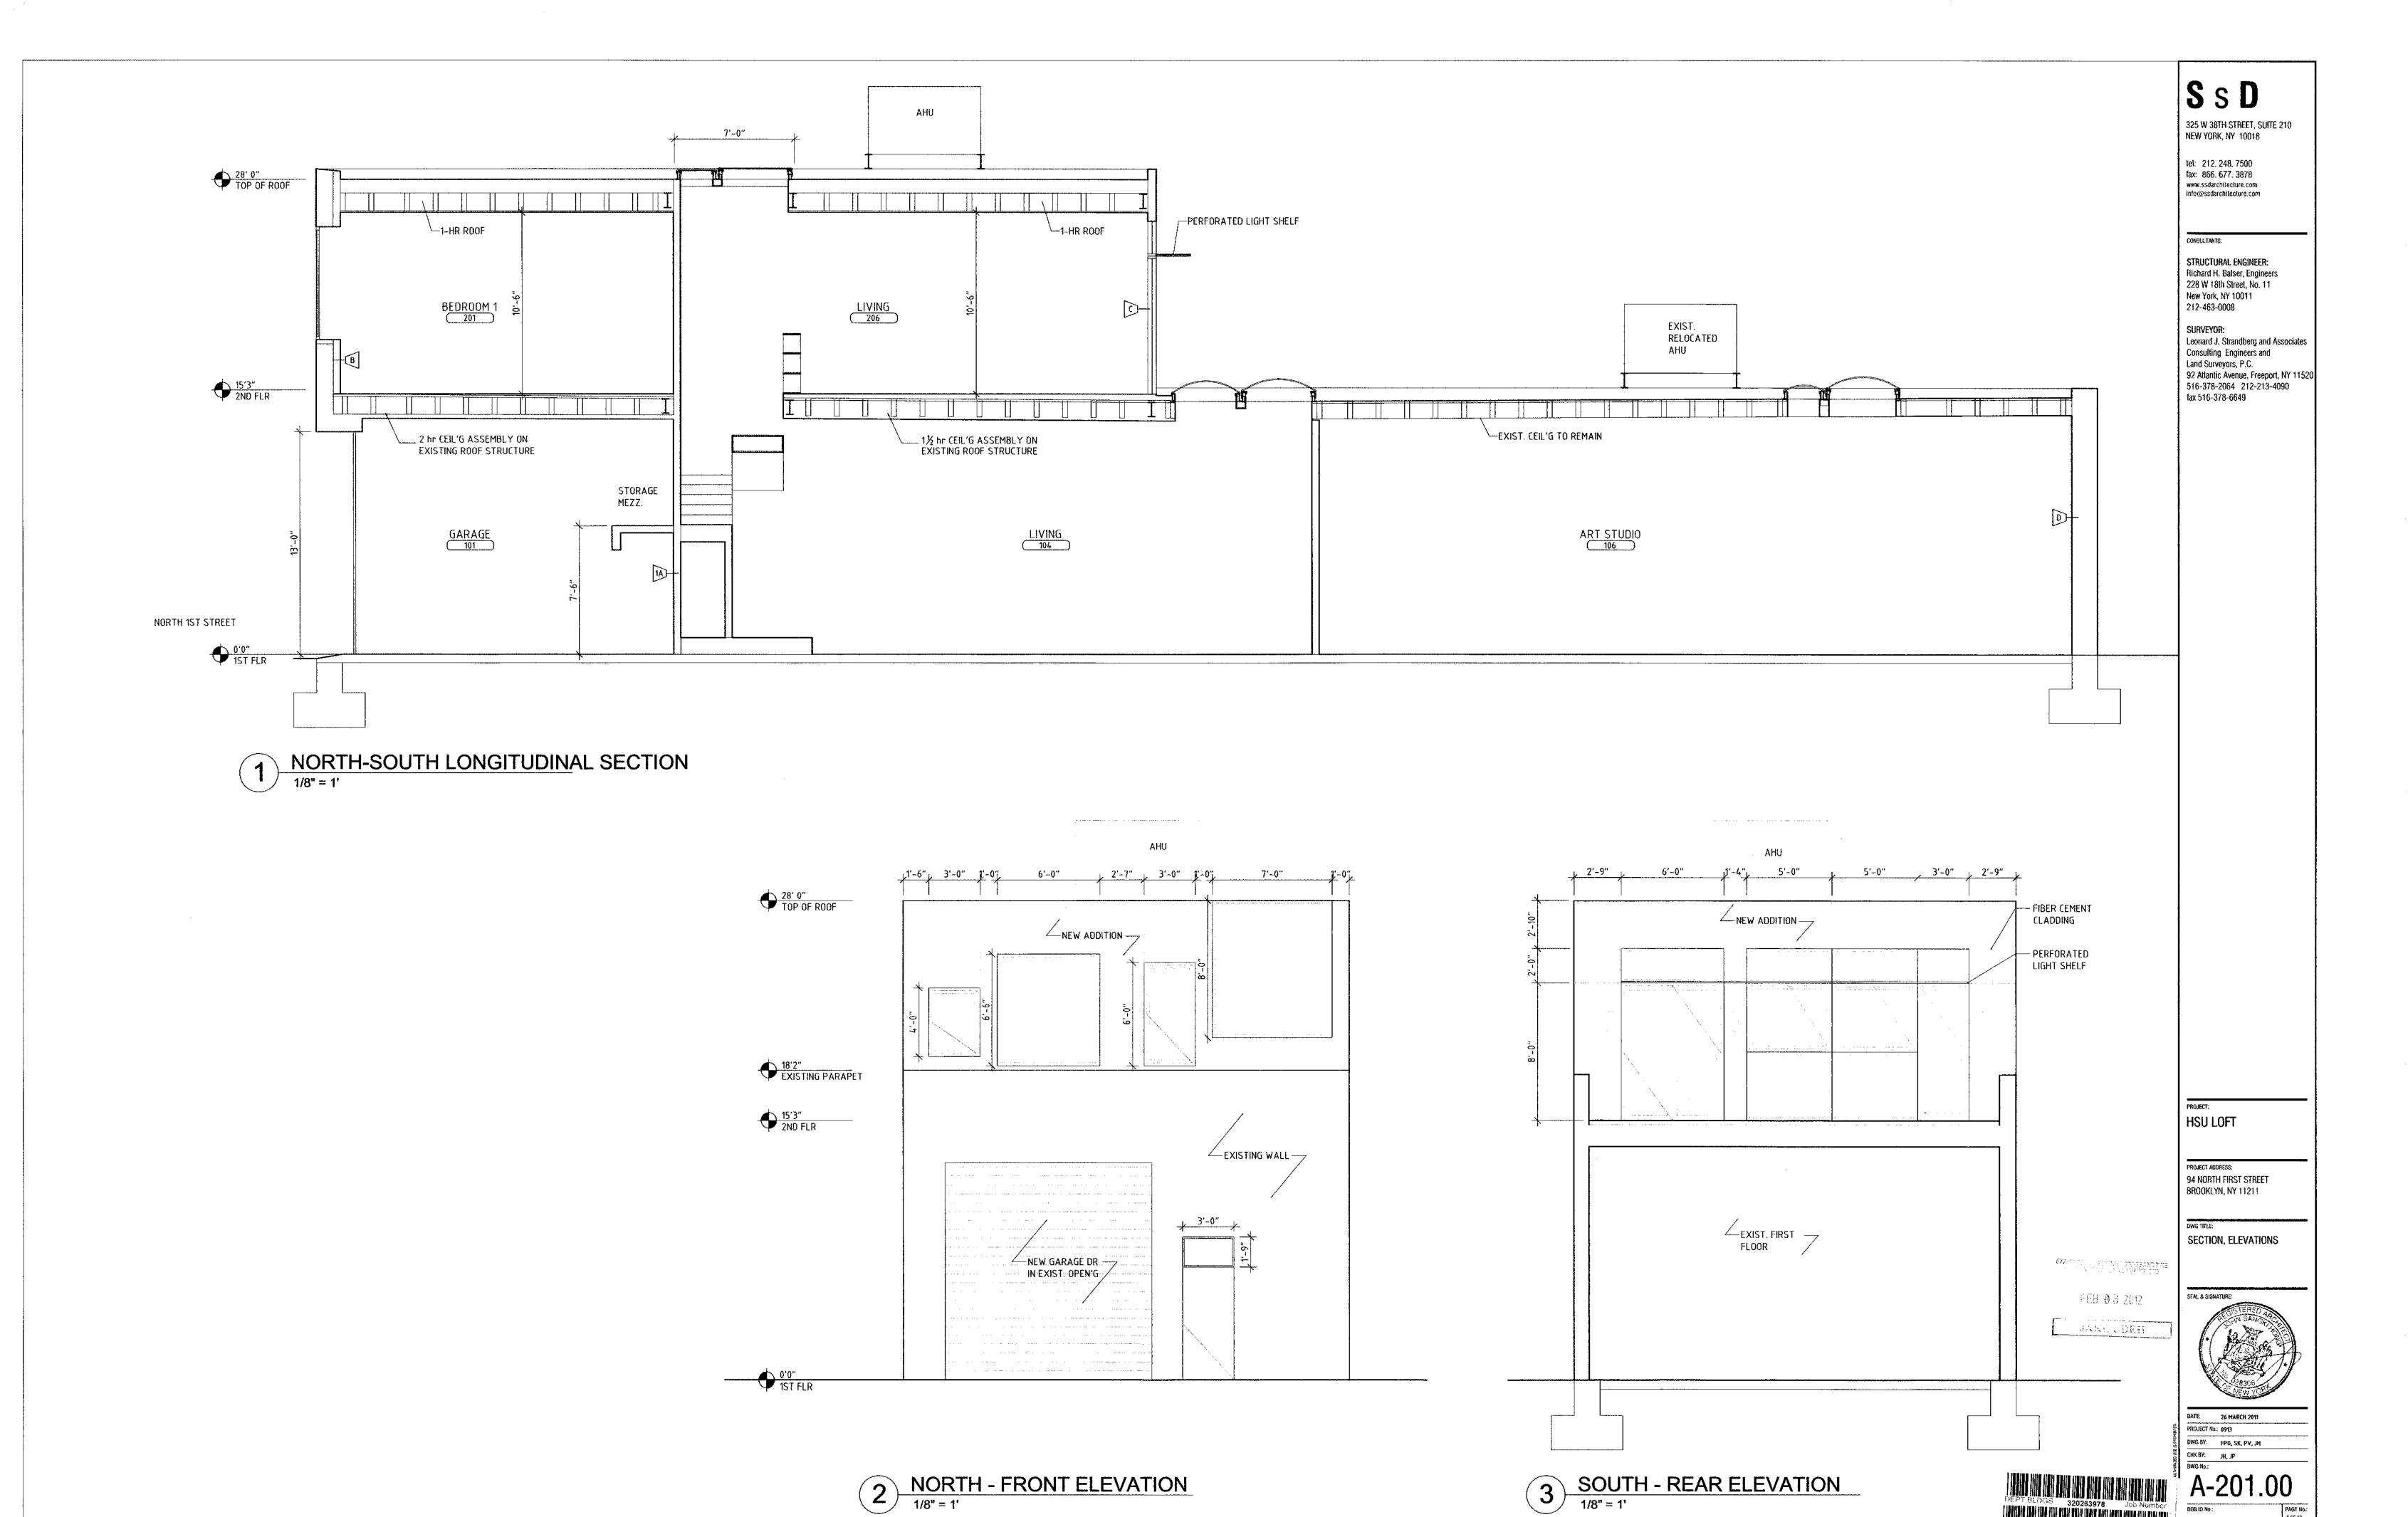

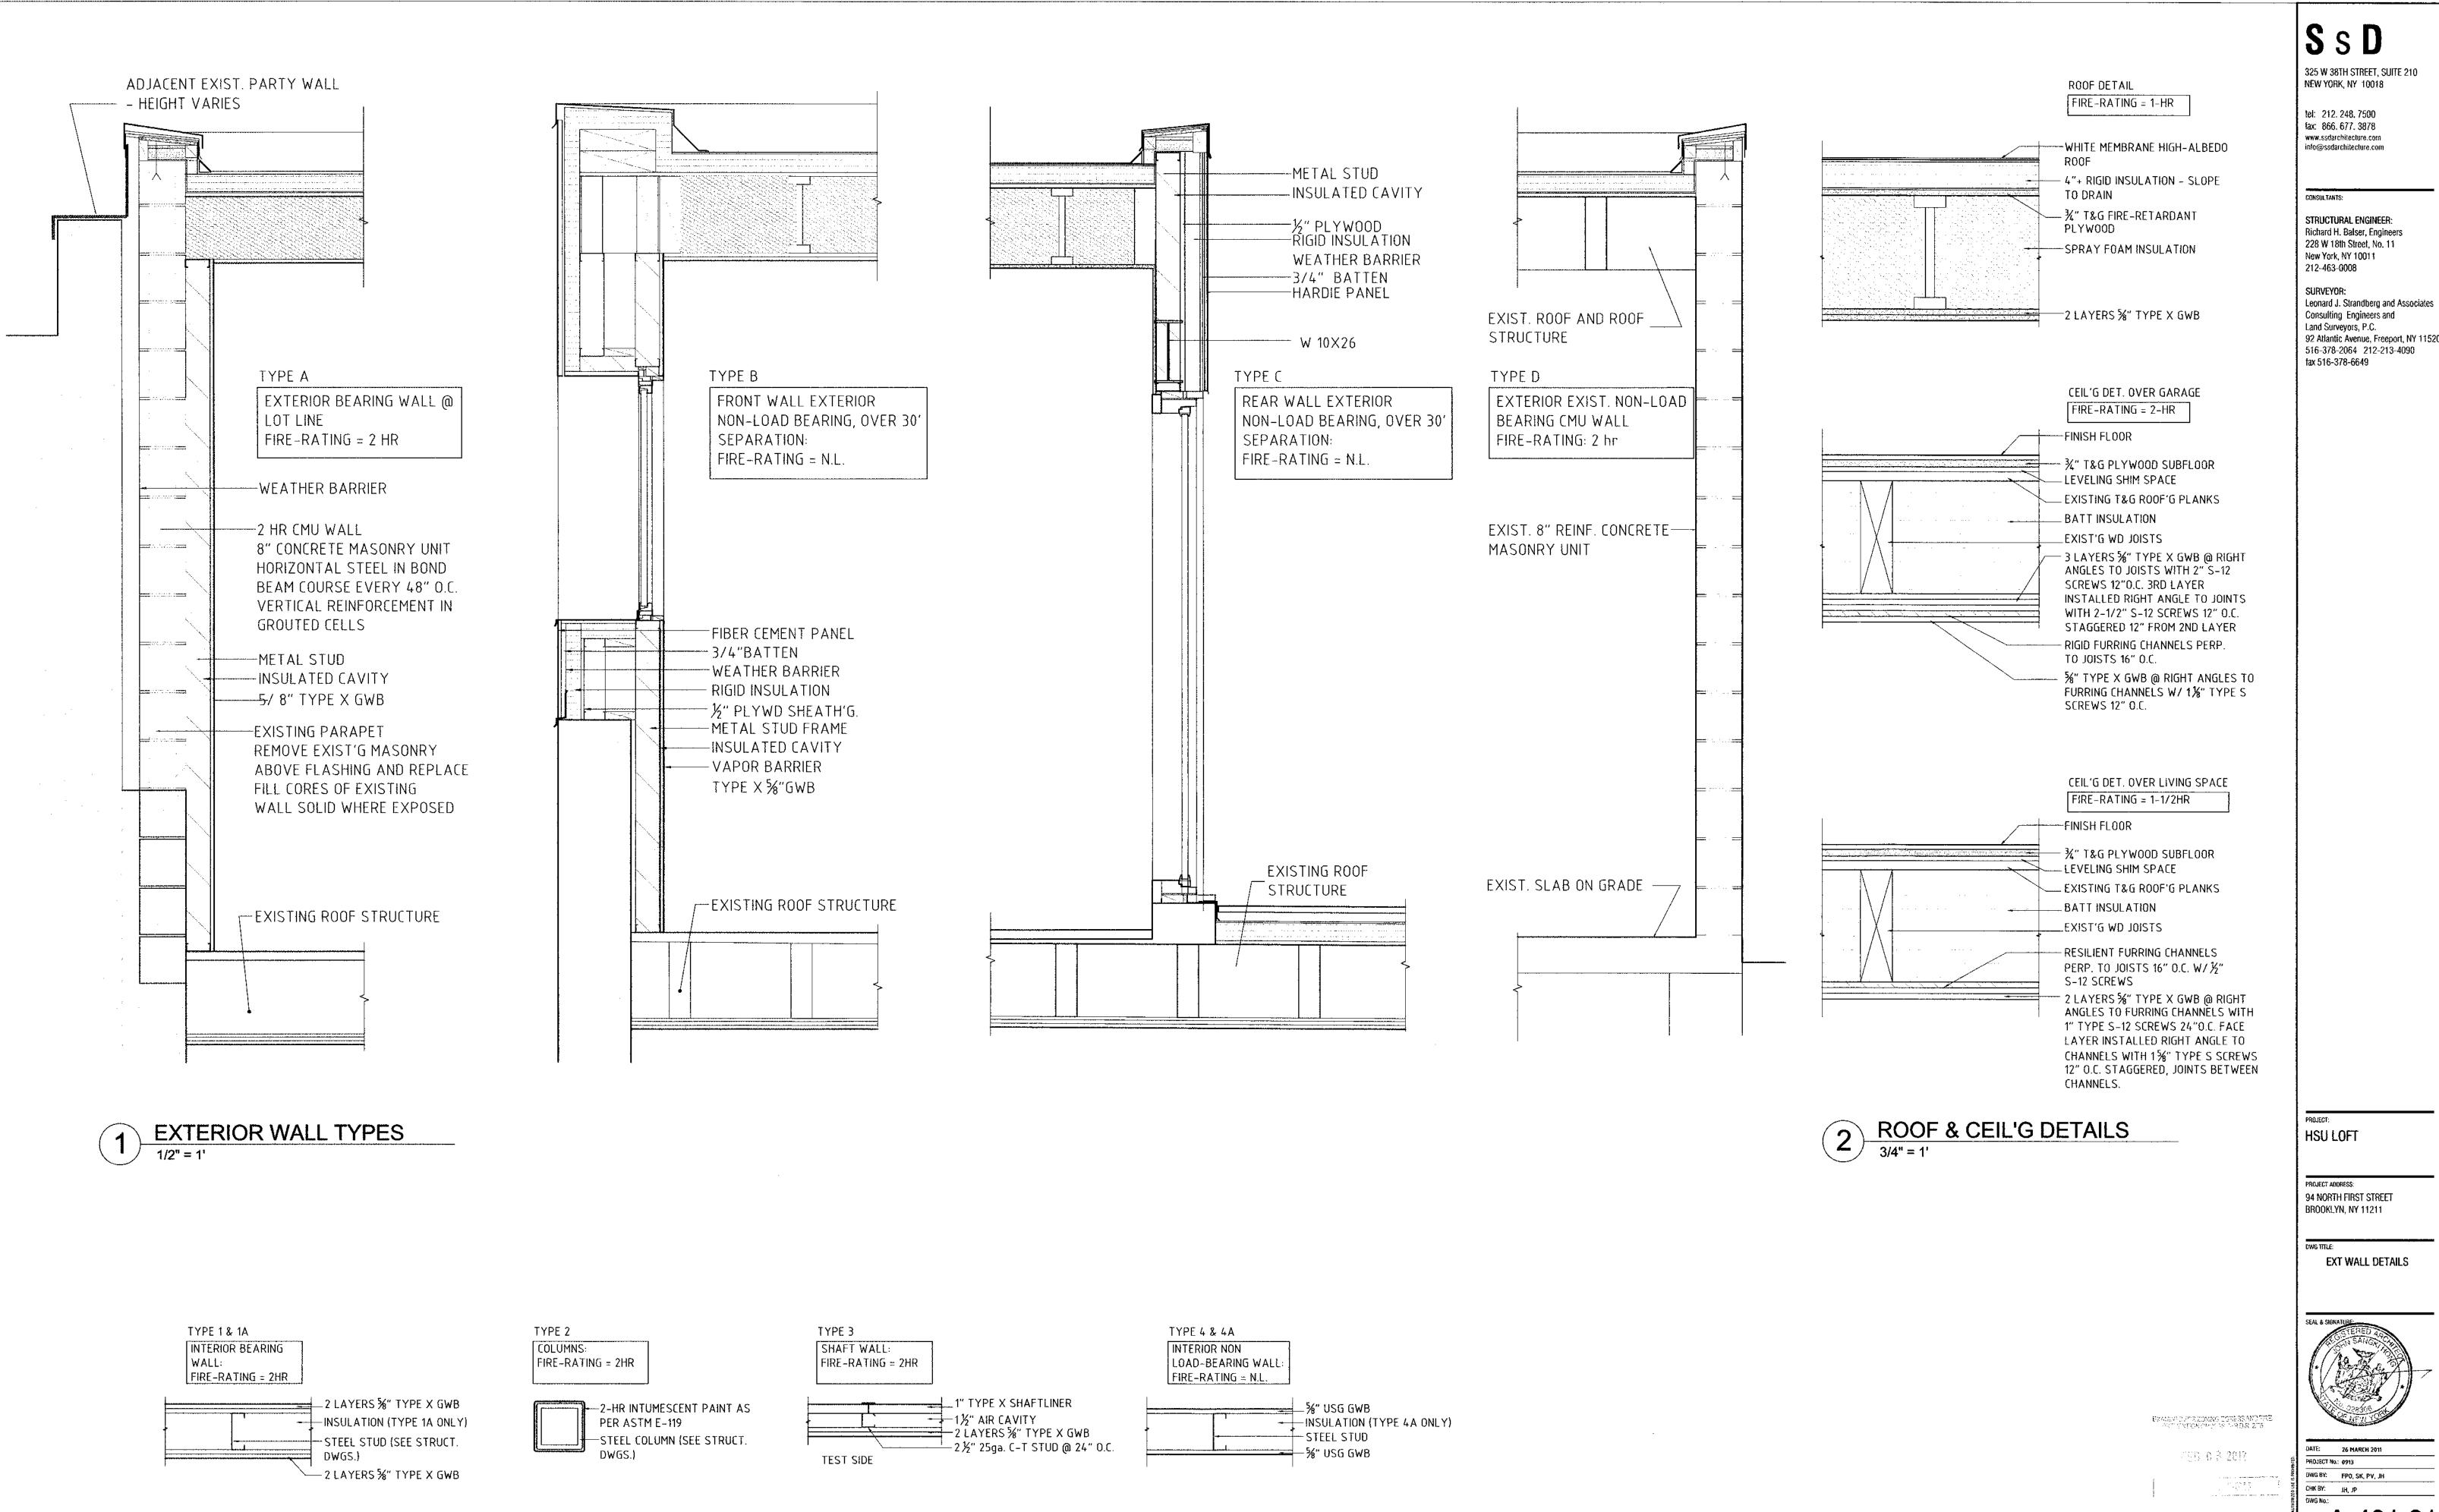


INT WALL DETAILS

DEPT.BLDGS 320263978 Job Number


SC340767240 Scan Code

WG No.: A-401.0

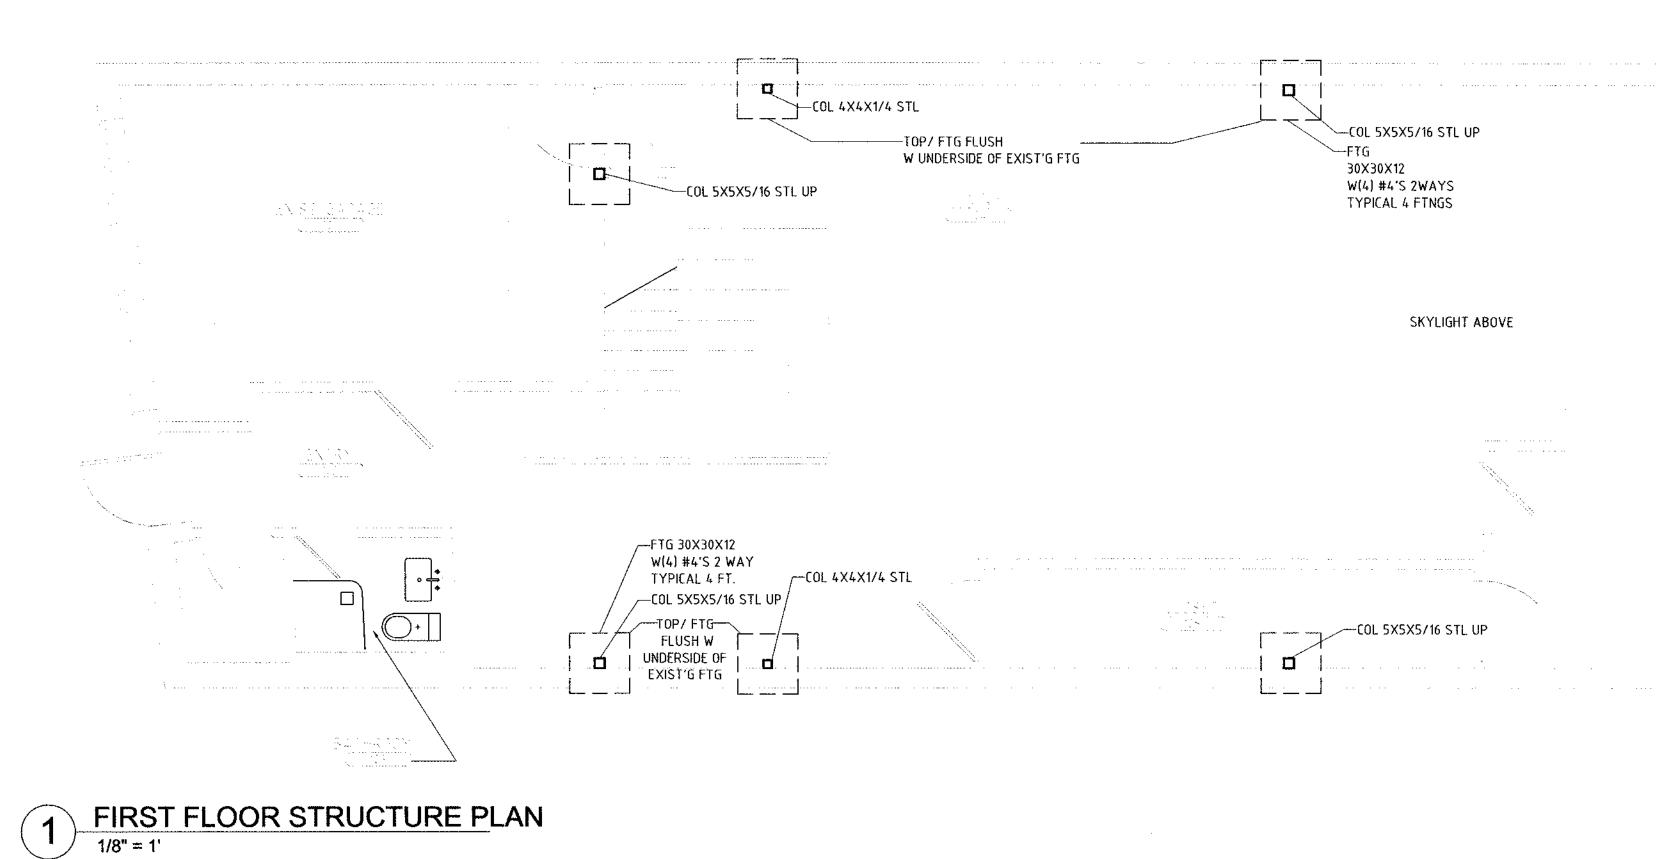

WAINED SPER BB2009 -026 TRIZ AND TR3 EXEMPT STRUCTURAL CONC. OF LESS THAN GO CU. YARDS OF 4,000 PSI OR COREATER

SKYLIGHT ABOVE

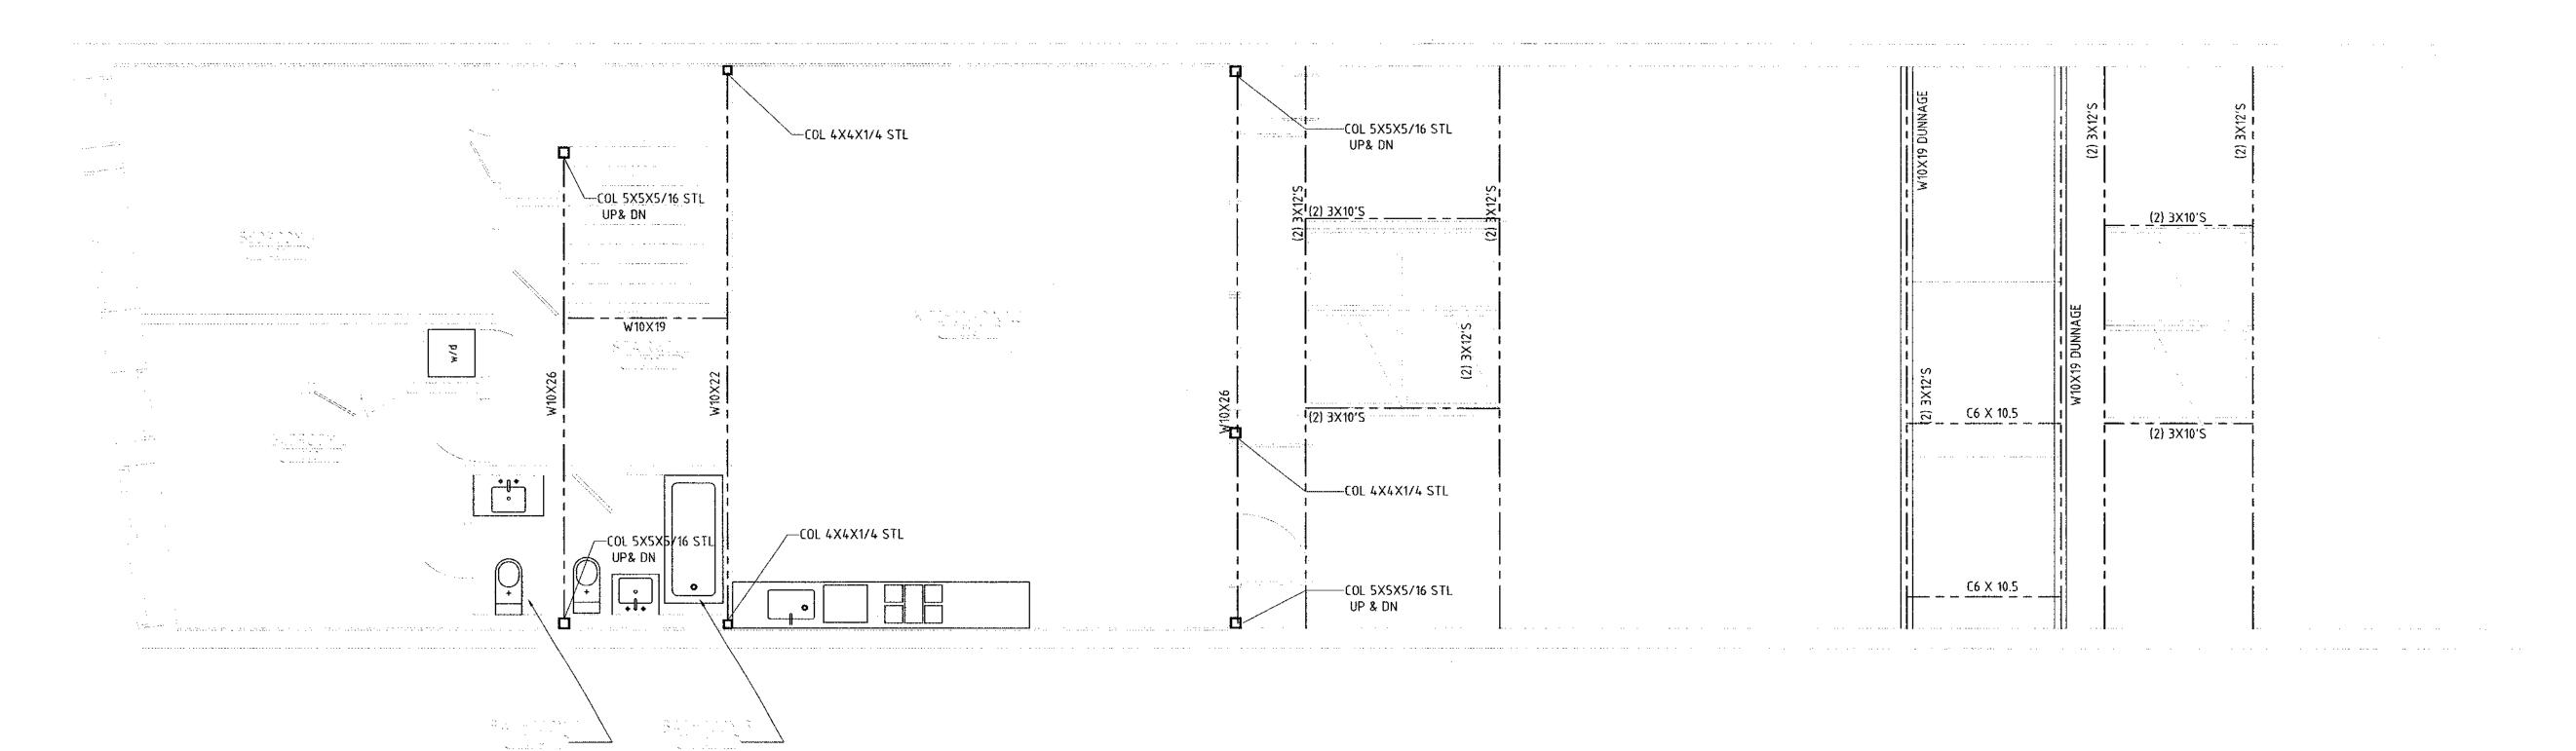

2 2ND FLOOR STRUCTURE PLAN
1/8" = 1'



BAEV PLACE DATA 98 EXMANEDALL/SQUING EQ., S s D

325 W 38TH STREET, SUITE 210 NEW YORK, NY 10018

tel: 212, 248, 7500 fax: 866, 677, 3878 www.ssdarchitecture.com into@ssdarchitecture.com

CONSULTANTS:

STRUCTURAL ENGINEER: Richard H. Balser, Engineers 228 W 18th Street, No. 11 New York, NY 10011 212-463-0008

SURVEYOR:
Leonard J. Strandberg and Associates
Consulting Engineers and
Land Surveyors, P.C.
92 Atlantic Avenue, Freeport, NY 11520
516-378-2064 212-213-4090
fax 516-378-6649

PROJECT: HSU LOFT

PROJECT ADDRESS:

94 NORTH FIRST STREET
BROOKLYN, NY 11211


STRUCTURAL PLANS, 1ST FLR, 2ND FLR




DATE: 26 MARCH 2019 PROJECT No.: 0913

DWG BY: FP0, SK, PV, JH
CHK BY: JH, JP
DWG No.:
S-101.00

No.: PAGE No 9 OF 10

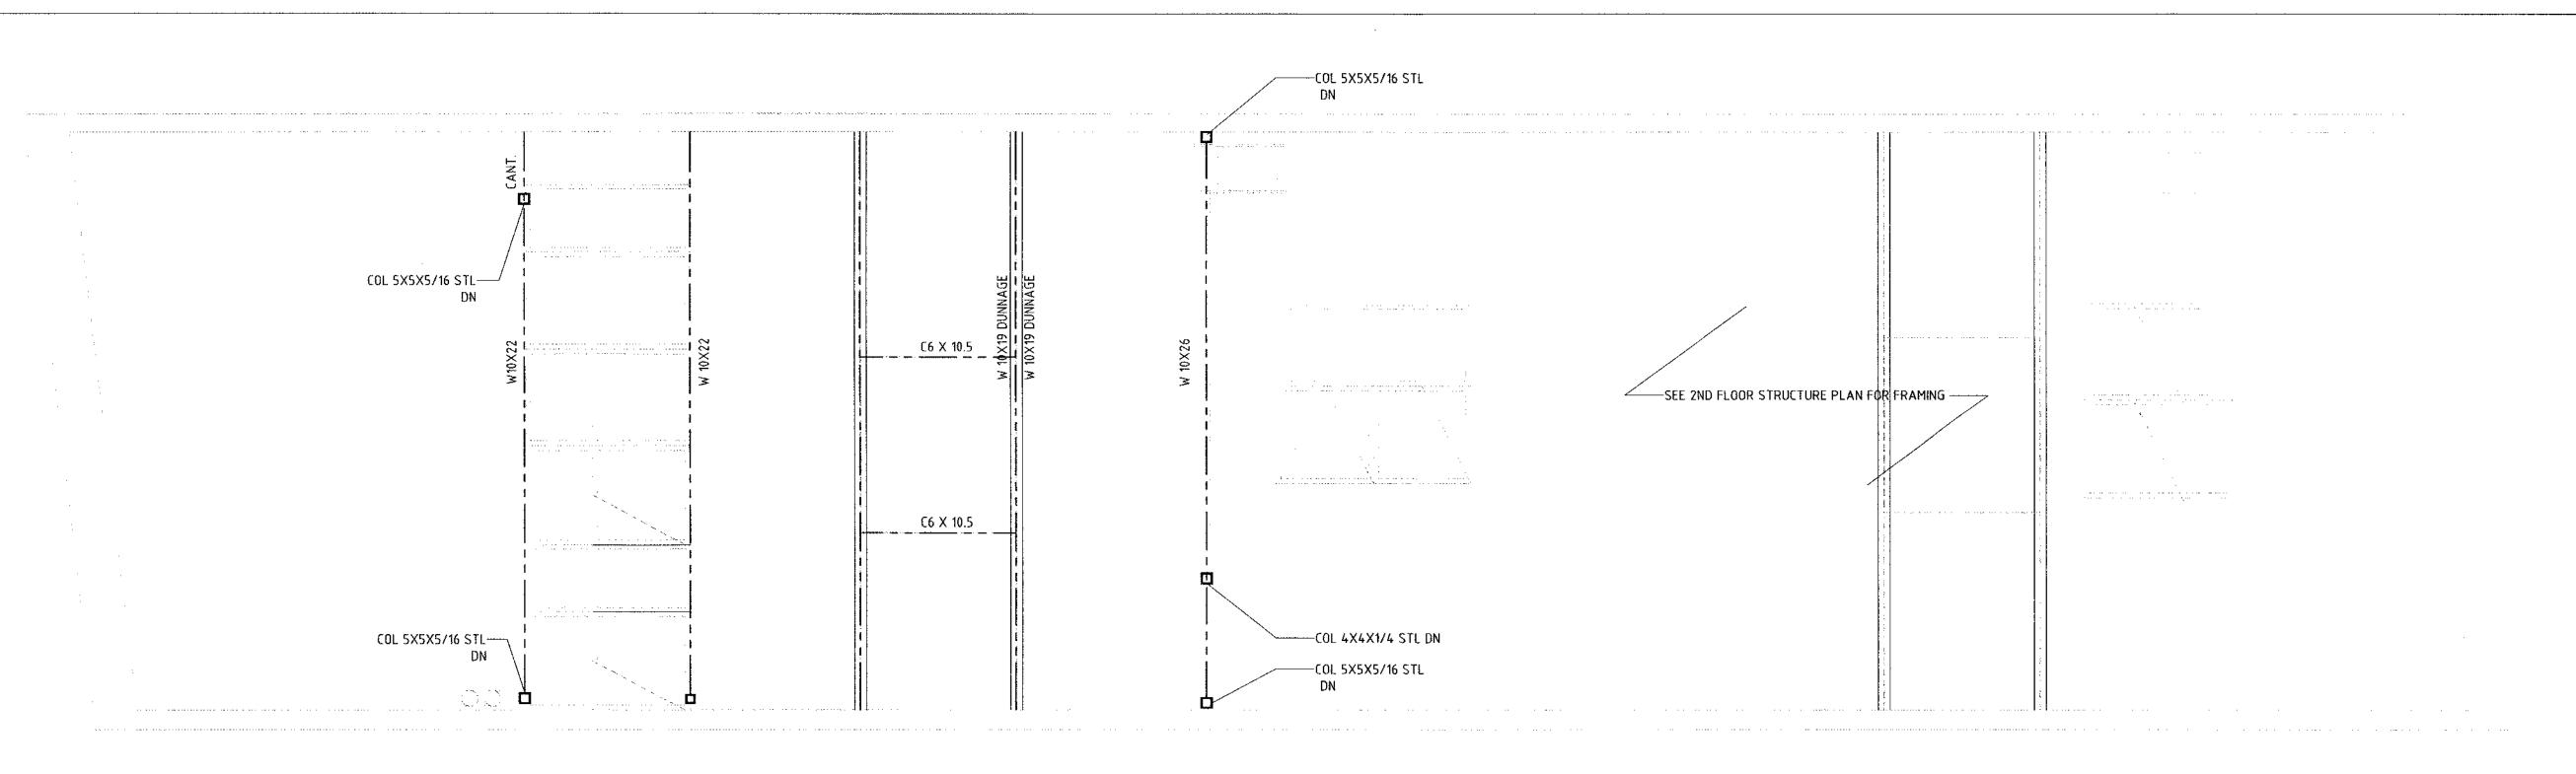

ROOF STRUCTURE PLAN
1/4" = 1'

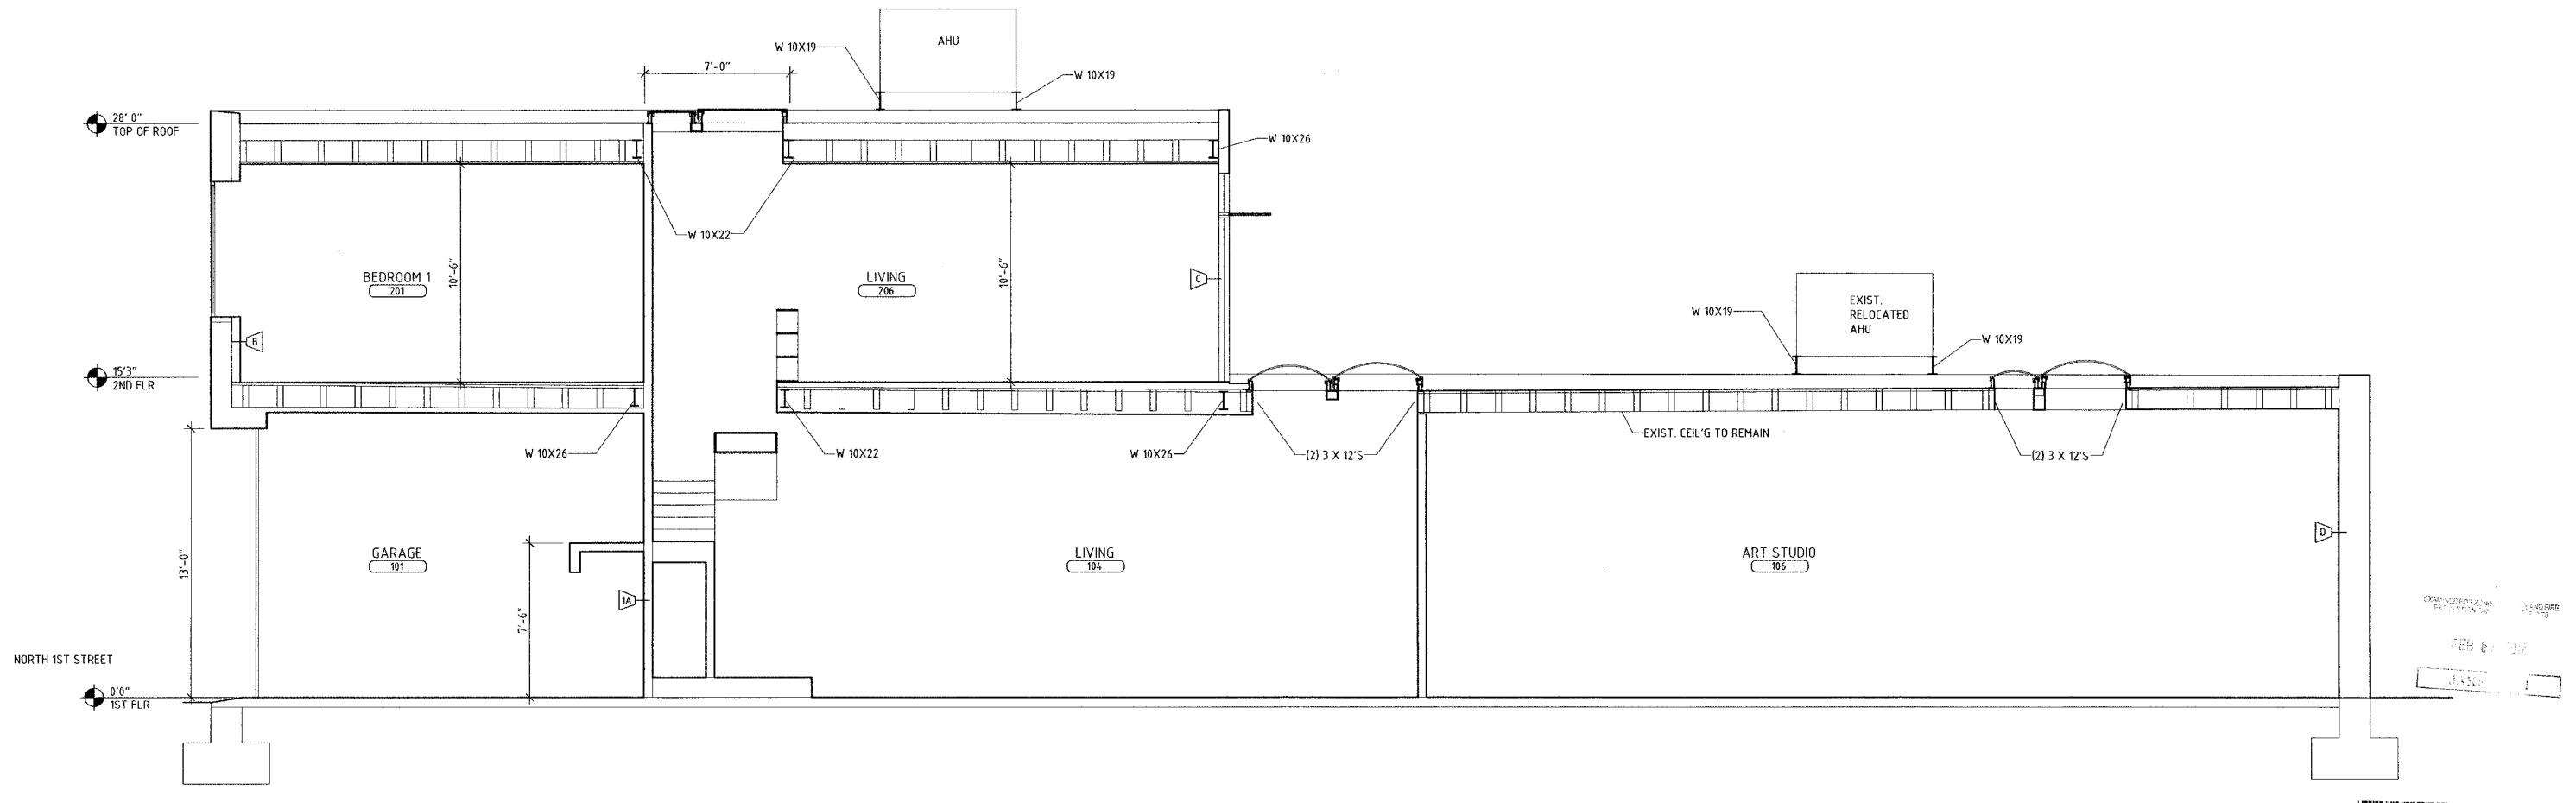

STRUCTURE SECTION

1/4" = 1'

**S** S **D** 

325 W 38TH STREET, SUITE 210 NEW YORK, NY 10018

tel: 212, 248, 7500 fax: 866, 677, 3878 www.ssdarchitecture.com info@ssdarchitecture.com

CONSULTANTS:

STRUCTURAL ENGINEER: Richard H. Balser, Engineers 228 W 18th Street, No. 11 New York, NY 10011 212-463-0008


SURVEYOR: Leonard J. Strandberg and Associates
Consulting Engineers and
Land Surveyors, P.C.
92 Atlantic Avenue, Freeport, NY 11520
516-378-2064 212-213-4090
fax 516-378-6649

HSU LOFT

PROJECT ADDRESS:

94 NORTH FIRST STREET
BROOKLYN, NY 11211

STRUCTURE ROOF PLAN, STRUCTURE SECTION

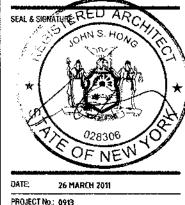


DATE: 26 MARCH 2011
PROJECT No.: 0913

DWG 8Y: FPO, SK, PV, JH

CHK BY: JH, JP

DWG No.:

S-102.00

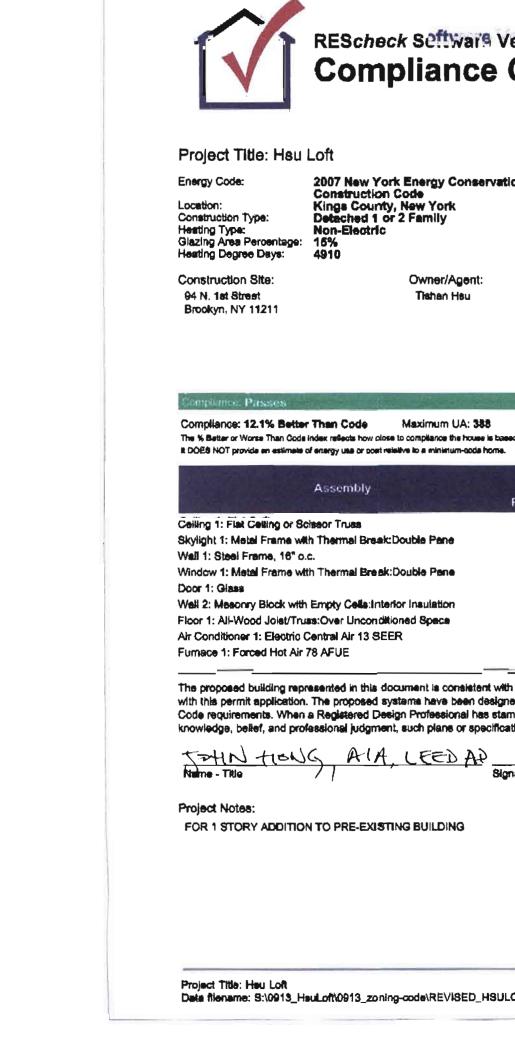



### Project Title: Hau Loft

2007 New York Energy Conservation Construction Code Kings County, New York Detsched 1 or 2 Family Non-Electric

Location: Kings
Construction Type: Detact
Heating Type: Non-El
Glazing Area Percentage: 15%
Heating Degree Days: 4910

Owner/Agent: Tishan Hau Brookyn, NY 11211

John Hong SaD Architecture 325 W 38th 8t. Sulte 210 New York, NY 10018 212 248 7500 Info@asdarchitecture.com

Designer/Contractor:

Compliance: 12.1% Better Than Code Maximum UA: 388 Your UA: 341 The % Better or Worse Than Gods Index reflects how close to compliance the house is based on code trade-off rules.

Assembly	Area or Perimeter	R-Value	R-Value	or Door U-Factor	UA
Ceiling 1: Flat Ceiling or Scissor Truss	965	40.0	15.0		16
Skylight 1: Metal Frame with Thermal Break:Double Pane	150			0.500	75
Well 1: Steel Frame, 16" o.c.	663	10.0	15.0		21
Window 1: Metal Frame with Thermal Break:Double Pane	214			0.460	98
Door 1: Glass	80			0.460	37
Well 2: Meaonry Block with Empty Cells:Interior insulation	1240	0.0	15.0		68
Floor 1: All-Wood Joiet/Truss:Over Unconditioned Space Air Conditioner 1: Electric Central Air 13 SEER	1042	40.0	0.0		26

The proposed building represented in this document is consistent with the building plans, specifications, and other calculations submitted with this permit application. The proposed systems have been designed to meet the 2007 New York Energy Conservation Construction Code requirements. When a Registered Design Professional has stamped and signed this page, they are attesting that to the best of his/her knowledge, belief, and professional judgment, such plans or specifications are in compliance with this Code.

Project Notes:

FOR 1 STORY ADDITION TO PRE-EXISTING BUILDING



Project Title: Heu Loft Data filename: 9:\0913\_HauLoft\0913\_zoning-code\REVISED\_HSULOFT\_RESCHECK.rok Report date: 10/12/10 Page 1 of 1

S S D

325 W 38TH STREET, SUITE 210 NEW YORK, NY 10018

tel: 212. 248. 7500 fax: 866. 677. 3878 www.ssdarchitecture.com info@ssdarchitecture.com

STRUCTURAL ENGINEER: Richard H. Balser, Engineers 6300 Route 9, PO Box 435, Chestertown, New York 12817 212-463-0008

SURVEYOR: Leonard J. Strandberg and Associates, Consulting Engineers and Land Surveyors, P.C. 92 Atlantic Avenue, Freeport, NY 11520 516-378-2064 212-213-4090 fax 516-378-6649

PROJECT:

**HSU LOFT** 

PROJECT ALDRESS: 94 NORTH FIRST STREET BROOKLYN, NY 11211

DWG TITLE:

**ENERGY ANALYSIS** 

SEAL & SIGNATURE:



26 OCTOBER 2010 PROJECT No.: 0913 DWG BY: SK, PV, JH, JP

PAGE No.: 9 0F 9 DOB ID No.:





9 FEB 0 3 2012

JAKE UDEH